


APRIL 14, 2017 Project Number: 195150441


WESTON, MASSACHUS CONCEPTUAL DESIGN SUBMITTAL

# PROPOSED WASTEWATER TREATMENT FACILITIES STONY BROOK APARTMENTS 104 BOSTON POST ROAD WESTON, MASSACHUSETTS

104 STONY BROOK, LLC P.O. BOX 158, WABAN, MASSACHUSETTS 02468

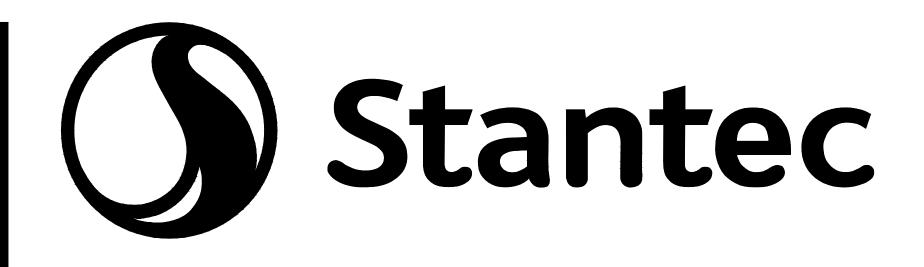

PROJECT SITE -

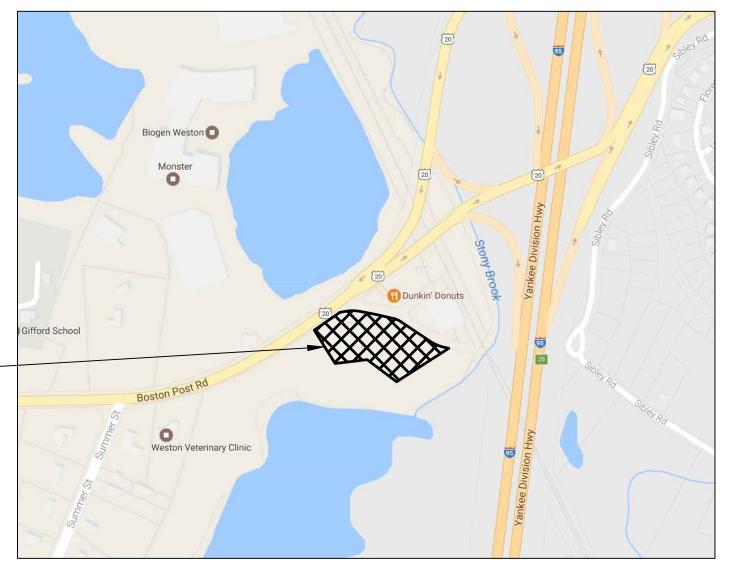

<u>SITE LOCUS MAP</u> 1'' = 400'


# LIST OF PLANS


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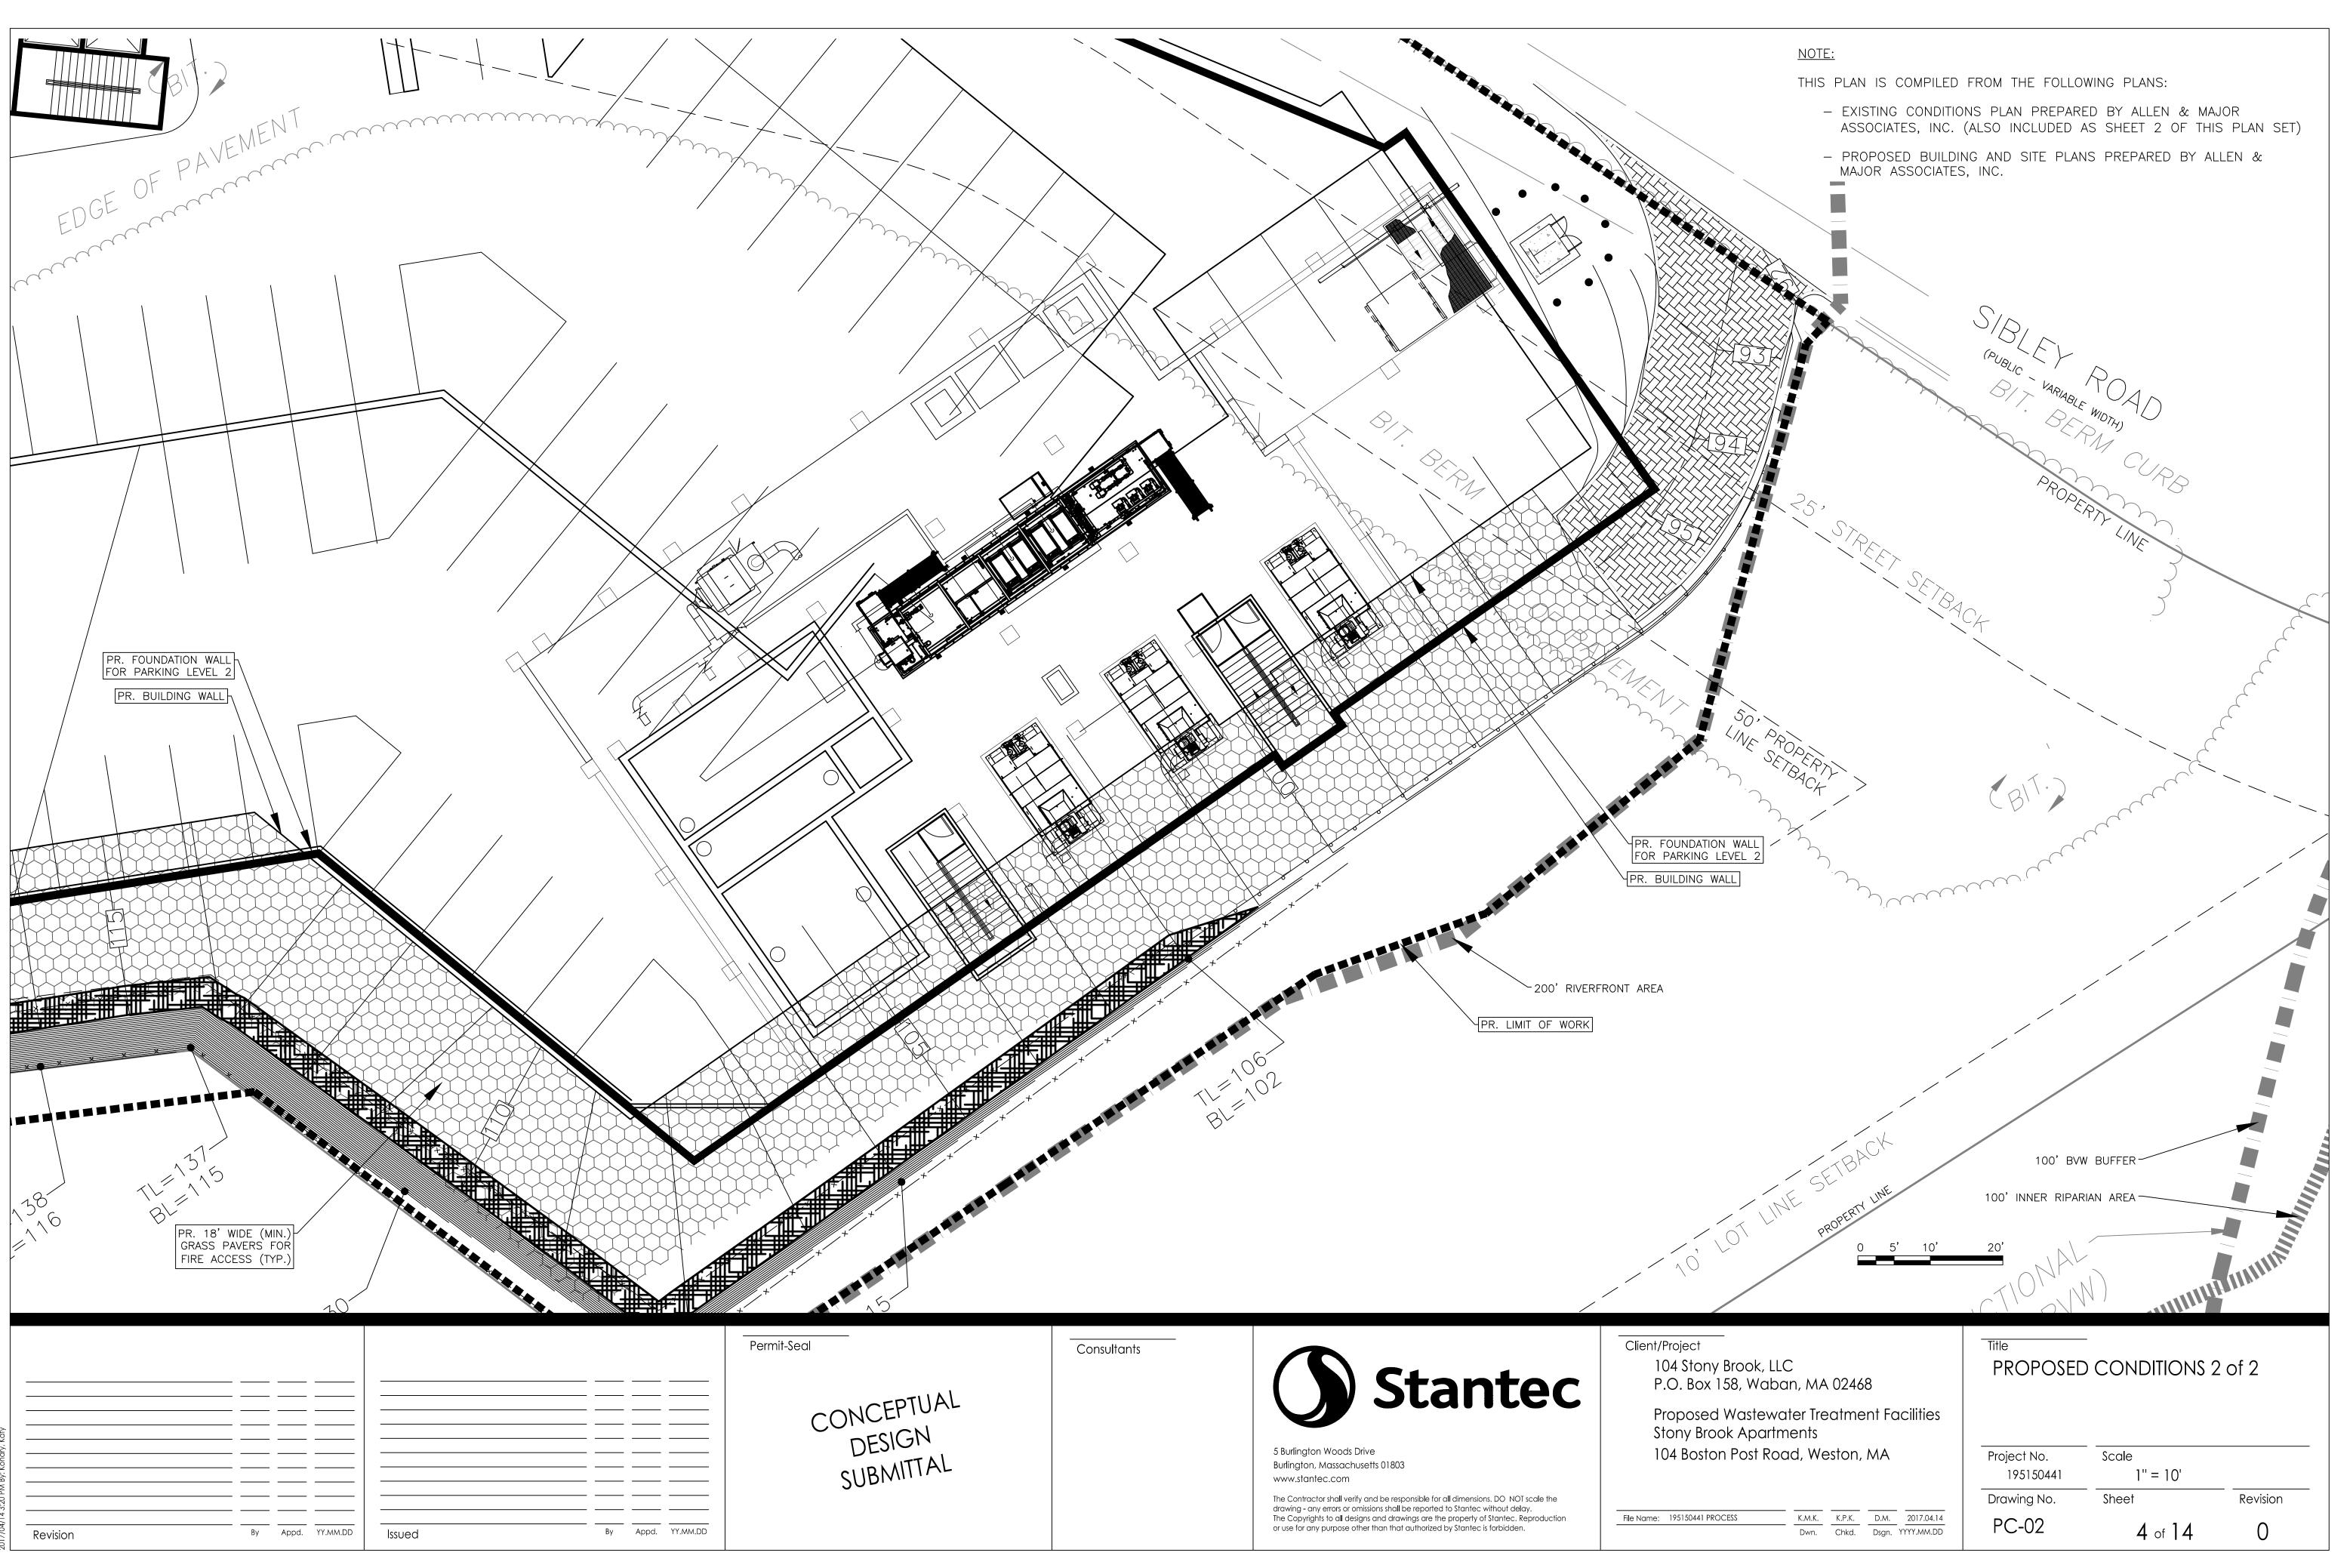
14

SHEET NO.	DWG NO.	TITLE
JILLI NO.		

-	COVER
EC-01	EXISTING CONDITIONS PLAN
PC-01	PROPOSED CONDITIONS PLAN 1 OF 2
PC-02	PROPOSED CONDITIONS PLAN 2 OF 2
N-01	NOTES AND CALCULATIONS
G-101	PROCESS FLOW DIAGRAM 1 OF 2
G-102	PROCESS FLOW DIAGRAM 2 OF 2
G-103	HYDRAULIC PROFILE
D-101	PROCESS BUILDING PLAN 1 OF 3
D-102	PROCESS BUILDING PLAN 2 OF 3
D-103	PROCESS BUILDING PLAN 3 OF 3
D-301	PROCESS BUILDING SECTION 1 OF 3
D-302	PROCESS BUILDING SECTION 2 OF 3
D-303	PROCESS BUILDING SECTION 3 OF 3



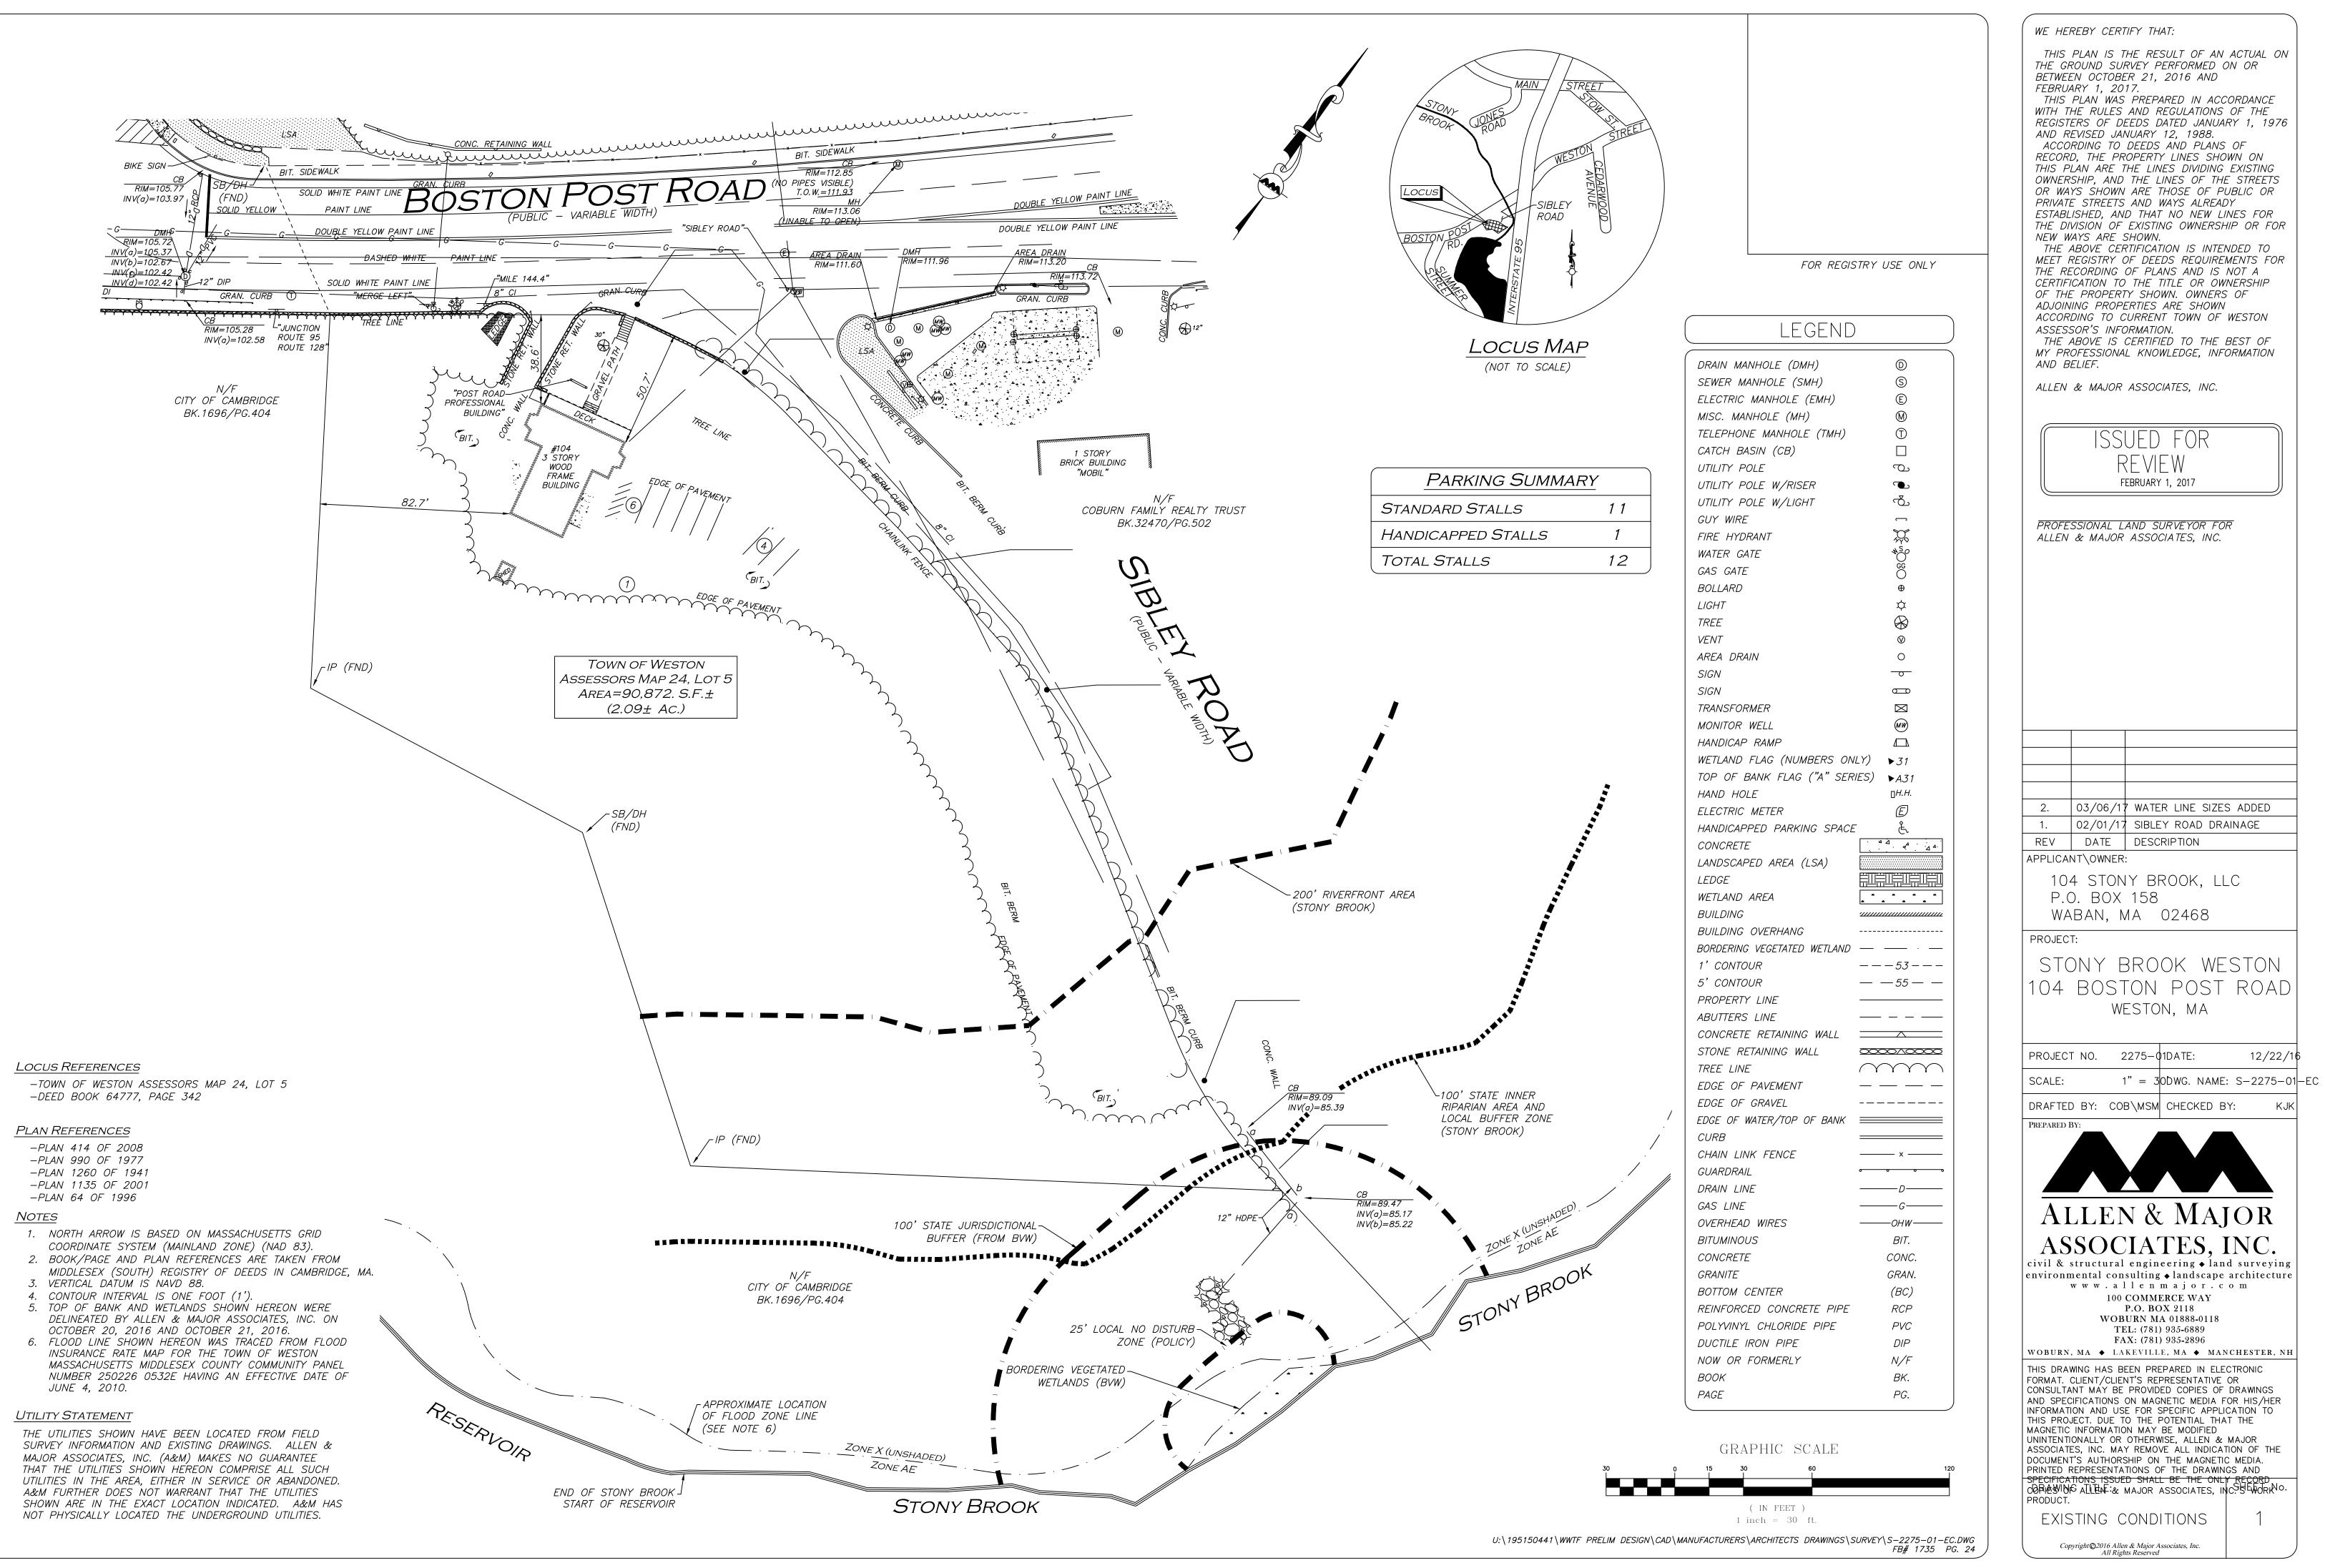

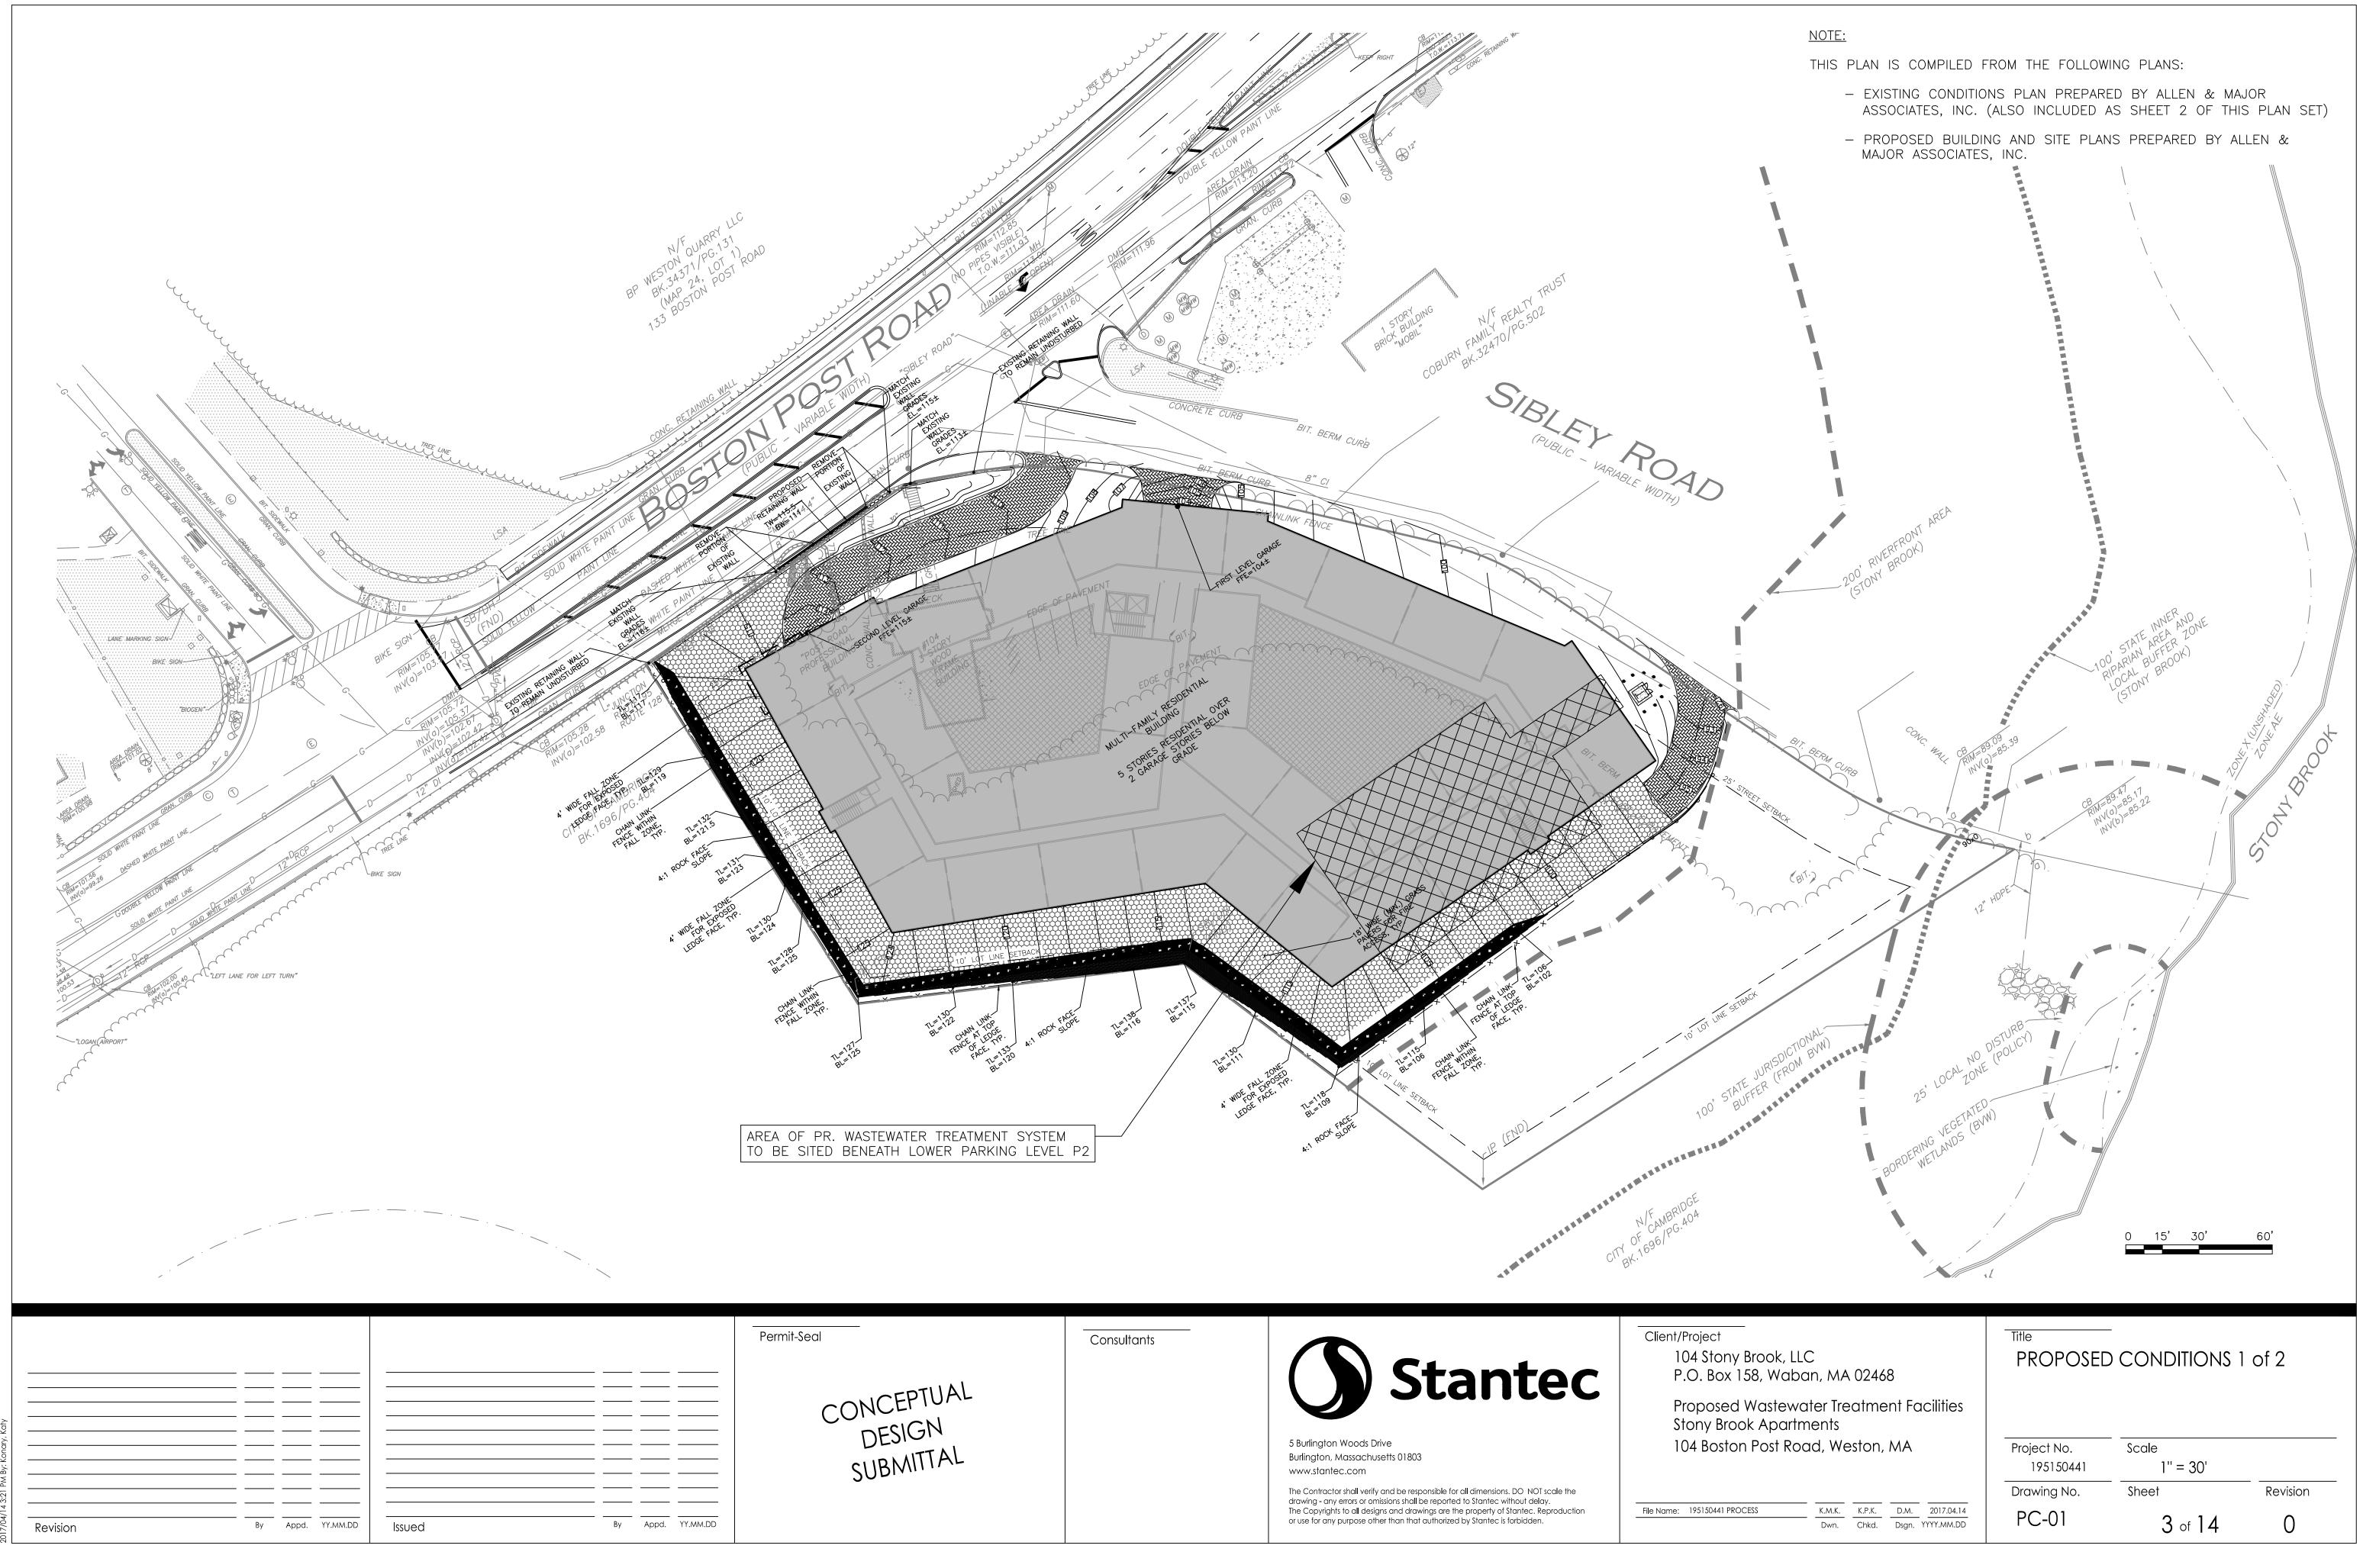

0441\WWTF Prelim Design\CAD\Design\Process\195150441 SITE.dv

GENERAL (	CONSTRUCTION	NOTES:
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- 1. THE CONTRACTOR IS RESPONSIBLE FOR COMPLIANCE WITH THE NOTES AND SPECIFICATIONS CONTAINED HEREIN. THE CONTRACTOR IS RESPONSIBLE TO ENSURE THAT ALL SUBCONTRACTORS FULLY AND COMPLETELY CONFORM TO AND COMPLY WITH THESE REQUIREMENTS.
- 2. THE FOLLOWING DOCUMENTS ARE INCORPORATED BY REFERENCE AS PART OF THESE PLANS:
- ABBREVIATED NOTICE OF RESOURCE AREA DELINEATION PLANS PREPARED BY ALLEN & MAJOR ASSOCIATES, INC.

SITE AND BUILDING PLANS

- 3. THE MATERIALS AND CONSTRUCTION OF ALL PROPOSED UTILITIES SHALL CONFORM TO THE MASS. D.P.W. STANDARDS AND SPECIFICATIONS DATED 1988, OR AS MOST RECENTLY REVISED, AND SUPPLEMENTAL SPECIFICATIONS, AS WELL AS 310 CMR 15.000 TITLE 5 STATE ENVIRONMENTAL CODE, THE "GUIDELINES FOR THE DESIGN, CONSTRUCTION, OPERATION AND MAINTENANCE OF SMALL SEWAGE TREATMENT FACILITIES WITH LAND DISPOSAL" AND THE TOWN OF WESTON BOARD OF HEALTH RULES AND REGULATIONS.
- 4. ALL CONSTRUCTION METHODS AND MATERIALS, AS WELL AS ALL MATERIAL SHOP DRAWINGS AND MANUFACTURERS DATA SHALL REQUIRE THE WRITTEN APPROVAL OF STANTEC CONSULTING SERVICES, INC. (STANTEC) PRIOR TO FABRICATION AND INSTALLATION. STANTEC IS NOT RESPONSIBLE FOR ANY WORK FOR WHICH SHOP DRAWINGS AND/OR CONSTRUCTION MATERIALS HAVE NOT BEEN PRE-APPROVED BY STANTEC.
- 5. THE LOCATION AND ELEVATION OF ANY EXISTING AND PROPOSED UTILITIES SHALL BE CONSIDERED APPROXIMATE AND MUST BE VERIFIED BY THE CONTRACTOR PRIOR TO ANY CONSTRUCTION. UNDERGROUND UTILITIES SHOWN ARE FROM FIELD OBSERVATION AND THE BEST AVAILABLE RECORD INFORMATION AND ARE NOT WARRANTED TO BE EXACT, NOR IS IT WARRANTED THAT ALL UNDERGROUND PIPES OR STRUCTURES ARE SHOWN. THE CONTRACTOR SHALL CONTACT THE RESPECTIVE UTILITY COMPANIES TO DETERMINE THE LOCATION, SIZE, MATERIALS AND ELEVATION OF ALL EXISTING UTILITIES, CONDUITS AND LINES.
- 6. THE CONTRACTOR SHALL CONTACT "DIG SAFE" AT 1-888-344-7233, 72 HOURS PRIOR TO ANY EXCAVATION AND/OR SUBSURFACE TESTING TO INFORM THE UTILITY COMPANIES OF ANY EXCAVATION.
- 7. WHENEVER EXISTING STRUCTURES ARE ENCOUNTERED, THE CONTRACTOR SHALL REPAIR ANY DAMAGED STRUCTURES OR REPLACE ANY REMOVED STRUCTURES, AND MAKE ANY IMPROVEMENTS ABOVE AND BELOW GRADE TO A CONDITION BETTER THAN OR EQUAL TO PRE-EXISTING CONDITIONS.
- 8. ALL EXCAVATED MATERIAL DESIGNATED FOR REUSE SHALL BE STOCKPILED ON SITE AND SHALL BE ENCLOSED BY TEMPORARY SILT FENCES TO PREVENT TRAVEL OF SEDIMENT TO ADJACENT PROPERTIES OR DRAINAGE WAYS.
- 9. THE CONTRACTOR SHALL BE RESPONSIBLE FOR THE DISPOSAL OF ALL WASTE MATERIAL AT A LOCATION APPROVED BY THE ENGINEER. BURIAL OF UNSUITABLE WASTE MATERIAL ON SITE WILL NOT BE PERMITTED.
- 10. EROSION CONTROL MEASURES SHALL REMAIN IN PLACE AND MAINTAINED IN GOOD CONDITION UNTIL SURFACE RESTORATION IS COMPLETE AND ALL AREAS DISTURBED BY THE CONTRACTORS OPERATIONS ARE STABILIZED. EROSION CONTROL MEASURES SHALL NOT BE REMOVED WITHOUT PRIOR APPROVAL FROM THE ENGINEER AND THE LOCAL CONSERVATION COMMISSION.
- 11. THE CONTRACTOR SHALL PROTECT ADJACENT PROPERTIES AND WETLAND RESOURCE AREAS FROM ON-SITE CONSTRUCTION ACTIVITIES AND SHALL REMOVE ANY SEDIMENT OR DEBRIS DEPOSITED THEREON IMMEDIATELY.
- 12. DRAINAGE GENERATED AS A RESULT OF DEWATERING SHALL BE DISCHARGED TO EXISTING DRAINAGE COURSES WITH PROPER EROSION CONTROL MEASURES SUBJECT TO APPROVAL BY THE LOCAL CONSERVATION COMMISSION. DISCHARGE ONTO PAVEMENT, WETLANDS, OR PRIVATE PROPERTY SHALL NOT BE ALLOWED.
- 13. APPROVAL FROM THE ENGINEER. SHALL BE REQUIRED FOR ALL FIELD CHANGES IN THE WORK PRIOR TO IMPLEMENTATION. NO FIELD CHANGES SHALL BE MADE IN ANY SPECIFIED SITE WORK OR ANY MATERIALS FOR WHICH SHOP DRAWINGS HAVE BEEN SUBMITTED AND APPROVED WITHOUT PRIOR CONSULTATION OF STANTEC AND THE OWNER. ANY CHANGES SO MADE WITHOUT THE CONSENT OF THE ENGINEER SHALL, IF DEEMED UNACCEPTABLE BY THE ENGINEER, BE PROMPTLY REMOVED FROM THE WORK SITE AT NO EXPENSE TO THE OWNER OF THE PROJECT.
- 14. THE CONTRACTOR SHALL BE RESPONSIBLE FOR ALL SITE PREPARATION, THE FIELD STAKING OF THE FACILITIES, THE COORDINATION AND INSTALLATION OF ALL UTILITY CONNECTIONS, AND RELATED WORK INCLUDING BUT NOT LIMITED TO ALL NECESSARY SHORING, BRACING AND DEWATERING FOR THE COMPLETE INSTALLATION OF THE PROJECT FACILITIES DURING CONSTRUCTION.
- 15. THE CONTRACTOR SHALL MAKE APPLICATION FOR AND PAY ALL FEES FOR PERMITS REQUIRED TO CONSTRUCT THIS PROJECT.
- 16. AFTER THE CONTRACTOR HAS STAKED OUT THE FACILITIES TO BE CONSTRUCTED AND HAS THE APPROVED MATERIALS ON THE JOB, THE OWNERS REPRESENTATIVE SHALL BE NOTIFIED AT LEAST TWO WORKING DAYS IN ADVANCE OF CONSTRUCTION TO ARRANGE FOR AN INSPECTION.
- 17. STANTEC IMPLIES NO WARRANTY OR CERTIFICATION AS TO THE ACCURACY OF ANY BASE MAPS, UTILITY DESIGN OR RECORD PROPERTY LINE DATA SHOWN ON THESE PLANS.
- 18. STANTEC ASSUMES NO RESPONSIBILITY FOR THE USE OF THESE PLANS FOR ACTUAL CONSTRUCTION WITHOUT WRITTEN APPROVAL FOR CONSTRUCTION ISSUED BY STANTEC AND THE MASSACHUSETTS DEPARTMENT OF ENVIRONMENTAL PROTECTION.
- 19. UNLESS OTHERWISE NOTED, ANY EXISTING BITUMINOUS PAVEMENT AND CURBING SHALL BE REMOVED AND DISPOSED AT A LOCATION APPROVED BY THE ENGINEER.
- 20. ANY ERRORS, OMISSIONS AND CHANGES IN CONDITIONS AT THE SITE SHALL BE BROUGHT TO THE ATTENTION OF THE ENGINEER PRIOR TO PERFORMING THE RELATED WORK.
- 21. ALL OPEN EXCAVATIONS SHALL BE ADEQUATELY SAFEGUARDED BY PROVIDING TEMPORARY BARRICADES, CAUTION SIGNS, LIGHTS AND OTHER MEANS TO PREVENT ACCIDENTS TO PERSONS, AND DAMAGE TO PROPERTY. THE CONTRACTOR SHALL, AT HIS OWN EXPENSE, PROVIDE SUITABLE AND SAFE BRIDGES AND OTHER CROSSINGS FOR ACCOMMODATING TRAVEL BY PEDESTRIANS AND WORKMEN AND PROVIDE POLICE DETAILS AS NECESSARY.
- 22. ALL PROPOSED WATER SERVICES SHALL BE INSTALLED IN STRICT CONFORMANCE WITH THE REGULATIONS OF THE TOWN OF WESTON AND THE MASSACHUSETTS DEPARTMENT OF ENVIRONMENTAL PROTECTION.

## DESIGN FLOW

DESIGN CRITERIA FOR THE PROPOSED WASTEWATER TREATMENT FACILITY (WWTF) WAS ESTABLISHED IN ACCORDANCE WITH THE "GUIDELINES FOR THE DESIGN, CONSTRUCTION, OPERATION AND MAINTENANCE OF SMALL SEWAGE TREATMENT FACILITIES WITH LAND DISPOSAL" PUBLISHED BY THE MASSACHUSETTS DEPARTMENT OF ENVIRONMENTAL PROTECTION (MASSDEP).

THE PROPOSED RESIDENTIAL APARTME BEDROOMS.

THE PROPOSED WWTF WILL HAVE A DESIGN CAPACITY OF 25,850 GALLONS PER DAY (GPD). THE DESIGN FLOWS HAVE BEEN CALCULATED AS FOLLOWS:

235 BEDROOMS X 110 GPD/BEDROOM = 25,850 GPD

# WASTEWATER CHARACTERISTICS

DESIGN FLOW, MAX. DAILY FLOW (MDF) TOTAL BIOCHEMICAL OXYGEN DEMAND ( TOTAL SUSPENDED SOLIDS TOTAL NITROGEN (AS NITROGEN) AMMONIA NITROGEN (AS NITROGEN) TOTAL PHOSPHORUS ALKALINITY (AS CaCO3) TEMPERATURE

### DESIGN EFFLUENT CHARACTERISTICS

TOTAL BIOCHEMICAL OXYGEN DEMAND TOTAL SUSPENDED SOLIDS TOTAL NITROGEN (AS NITROGEN) AMMONIA NITROGEN (AS NITROGEN) PH (STANDARD UNITS) FECAL COLIFORM BACTERIA

# OVIVO MICRO-BLOX TREATMENT SYSTEM

COMPLETE SYSTEM DESIGN DATA IS INCLUDED IN THE BIOWIN DESIGN REPORT THAT HAS BEEN PREPARED FOR THIS PROJECT. A BRIEF SUMMARY OF THE SYSTEM PER OVIVIO microBLOX MODEL NUMBER FOLLOWS:

4Z	FOUR ZONE SYSTEM
V1	480 VAC / 3PH / 60HZ
F2	DUAL FINE SCREEN - FS 60
D1	ZONE 1 - DUAL MEMBRANES
D1	ZONE 2 - DUAL MEMBRANES
WA	ZONE 3 - WASTE ACTIVATED
AX	ZONE 4 - ANOXIC 4,000 GA
T2	DUAL 10 HP TRANSFER PUM
Ρ2	DUAL 10 HP PERMEATE PUM
U2	DUAL ULTRAVIOLET DISINFEC
S3	DUAL 10 HP IR PUMP + $O_2$
Β3	TRIPLE BLOWER
1	
1	INCLUDES ANALYTICS FOR TU
1	
1	
1	
1	INCLUDE CARBON ADDITION
2	EXCLUDE FLUX ENHANCER
2	EXCLUDE ALUM ADDITION (PH
1	INCLUDE PH ADJUSTMENT
1	
1	INCLUDE WALKWAY WITH RAIL
2	EXCLUDE STAINLESS STEEL F
2	
1	INCLUDE REMOTE DISCONNEC
1	INCLUDE STAIRS
2	
G	GREY (STANDARD COLOR)

			Permit-Seal	Consultants		Client/Project 104 Stor
M By: Konary, Kary			CONCEPTUAL DESIGN SUBMITTAL		5 Burlington, Massachusetts 01803 www.stantec.com	P.O. Box Propose Stony Bro 104 Bost
Revision	By Appd. YY.MM.DD Issued	By Appd. YY.MM.DD			The Contractor shall verify and be responsible for all dimensions. DO NOT scale the drawing - any errors or omissions shall be reported to Stantec without delay. The Copyrights to all designs and drawings are the property of Stantec. Reproduction or use for any purpose other than that authorized by Stantec is forbidden.	File Name: 195150441 F

THE PROPOSED RESIDENTIAL APARTMENT DEVELOPMENT WILL CONSIST OF TWO HUNDRED THIRTY FIVE (235)

	CONCENTRATION
)	25,850 GPD
(BOD)	250 MG/L
	250 MG/L
	35 MG/L
	35 MG/L
	8 MG/L
	300 MG/L
	55 <b>°</b> F

	PERMIT LIMIT	DESIGN TARGET
(BOD)	10 MG/L	< 5 MG/L
	10 MG/L	< 5 MG/L
	10 MG/L	< 5 MG/L
	-	< 2 MG/L
	6.5 TO 8.5	_
	0/100 ML	0/100 ML

S00 ES 0V104 ES 0V104 ED SLUDGE 4,200 GALLONS GALLONS MPS MPS CTION UNITS 30+ 2 + INJECTOR DISSOLVED OXYGEN

FURBIDITY FOTAL SUSPENDED SOLIDS NFLUENT MONITORING EFFLUENT MONITORING


PHOSPHORUS REDUCTION)

ED COVERS


FASTENERS

CTS

### Title NOTES AND CALCULATIONS ny Brook, LLC (158, Waban, MA 02468) ed Wastewater Treatment Facilities rook Apartments ton Post Road, Weston, MA Project No. Scale NOT TO SCALE 195150441 Sheet Drawing No. Revision K.M.K. K.P.K. D.M. 2017.04.14 PROCESS N-01 5 of 14 0 Dwn. Chkd. Dsgn. YYYY.MM.DD

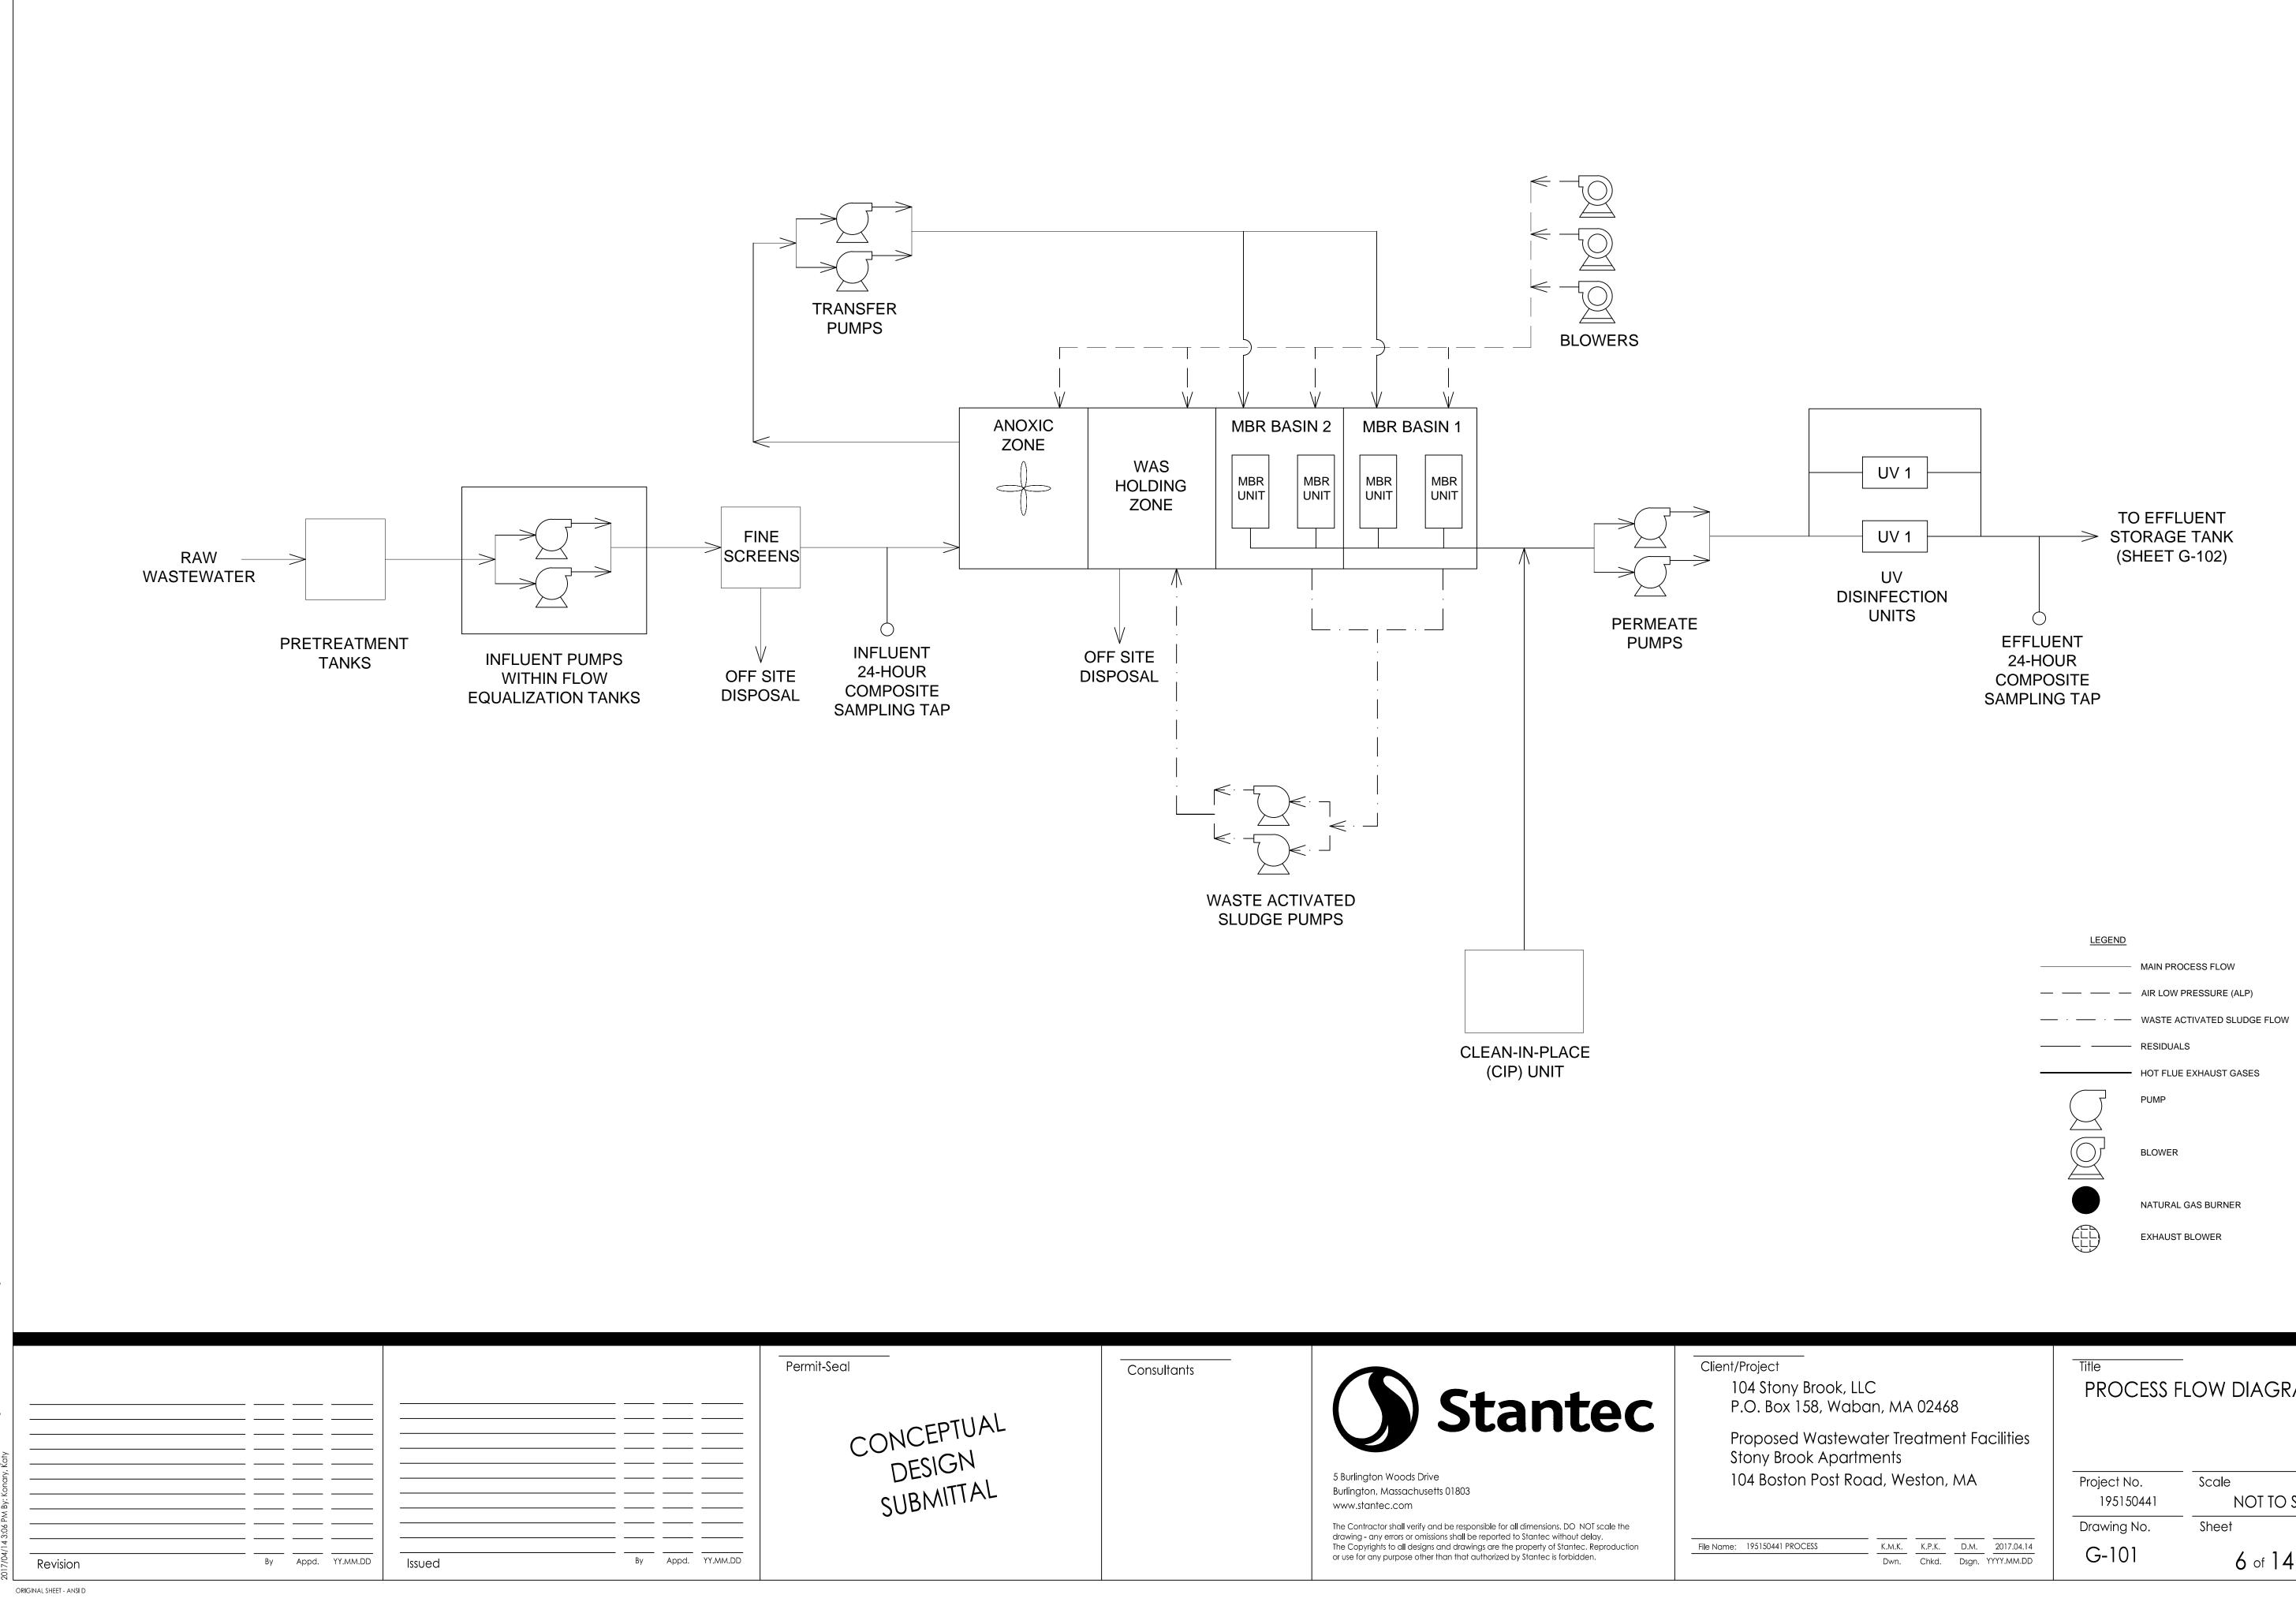


— ny Brook, LLC x 158, Waban, MA 02468	Title PROCESS F	- FLOW DIAGRAM	1 1 OF 2
ed Wastewater Treatment Facilities rook Apartments ton Post Road, Weston, MA	Project No. 195150441	Scale NOT TO SCA	
	Drawing No.	Sheet	Revision
PROCESS K.M.K. K.P.K. D.M. 2017.04.14 Dwn. Chkd. Dsgn. YYYY.MM.DD	G-101	6 of 14	0

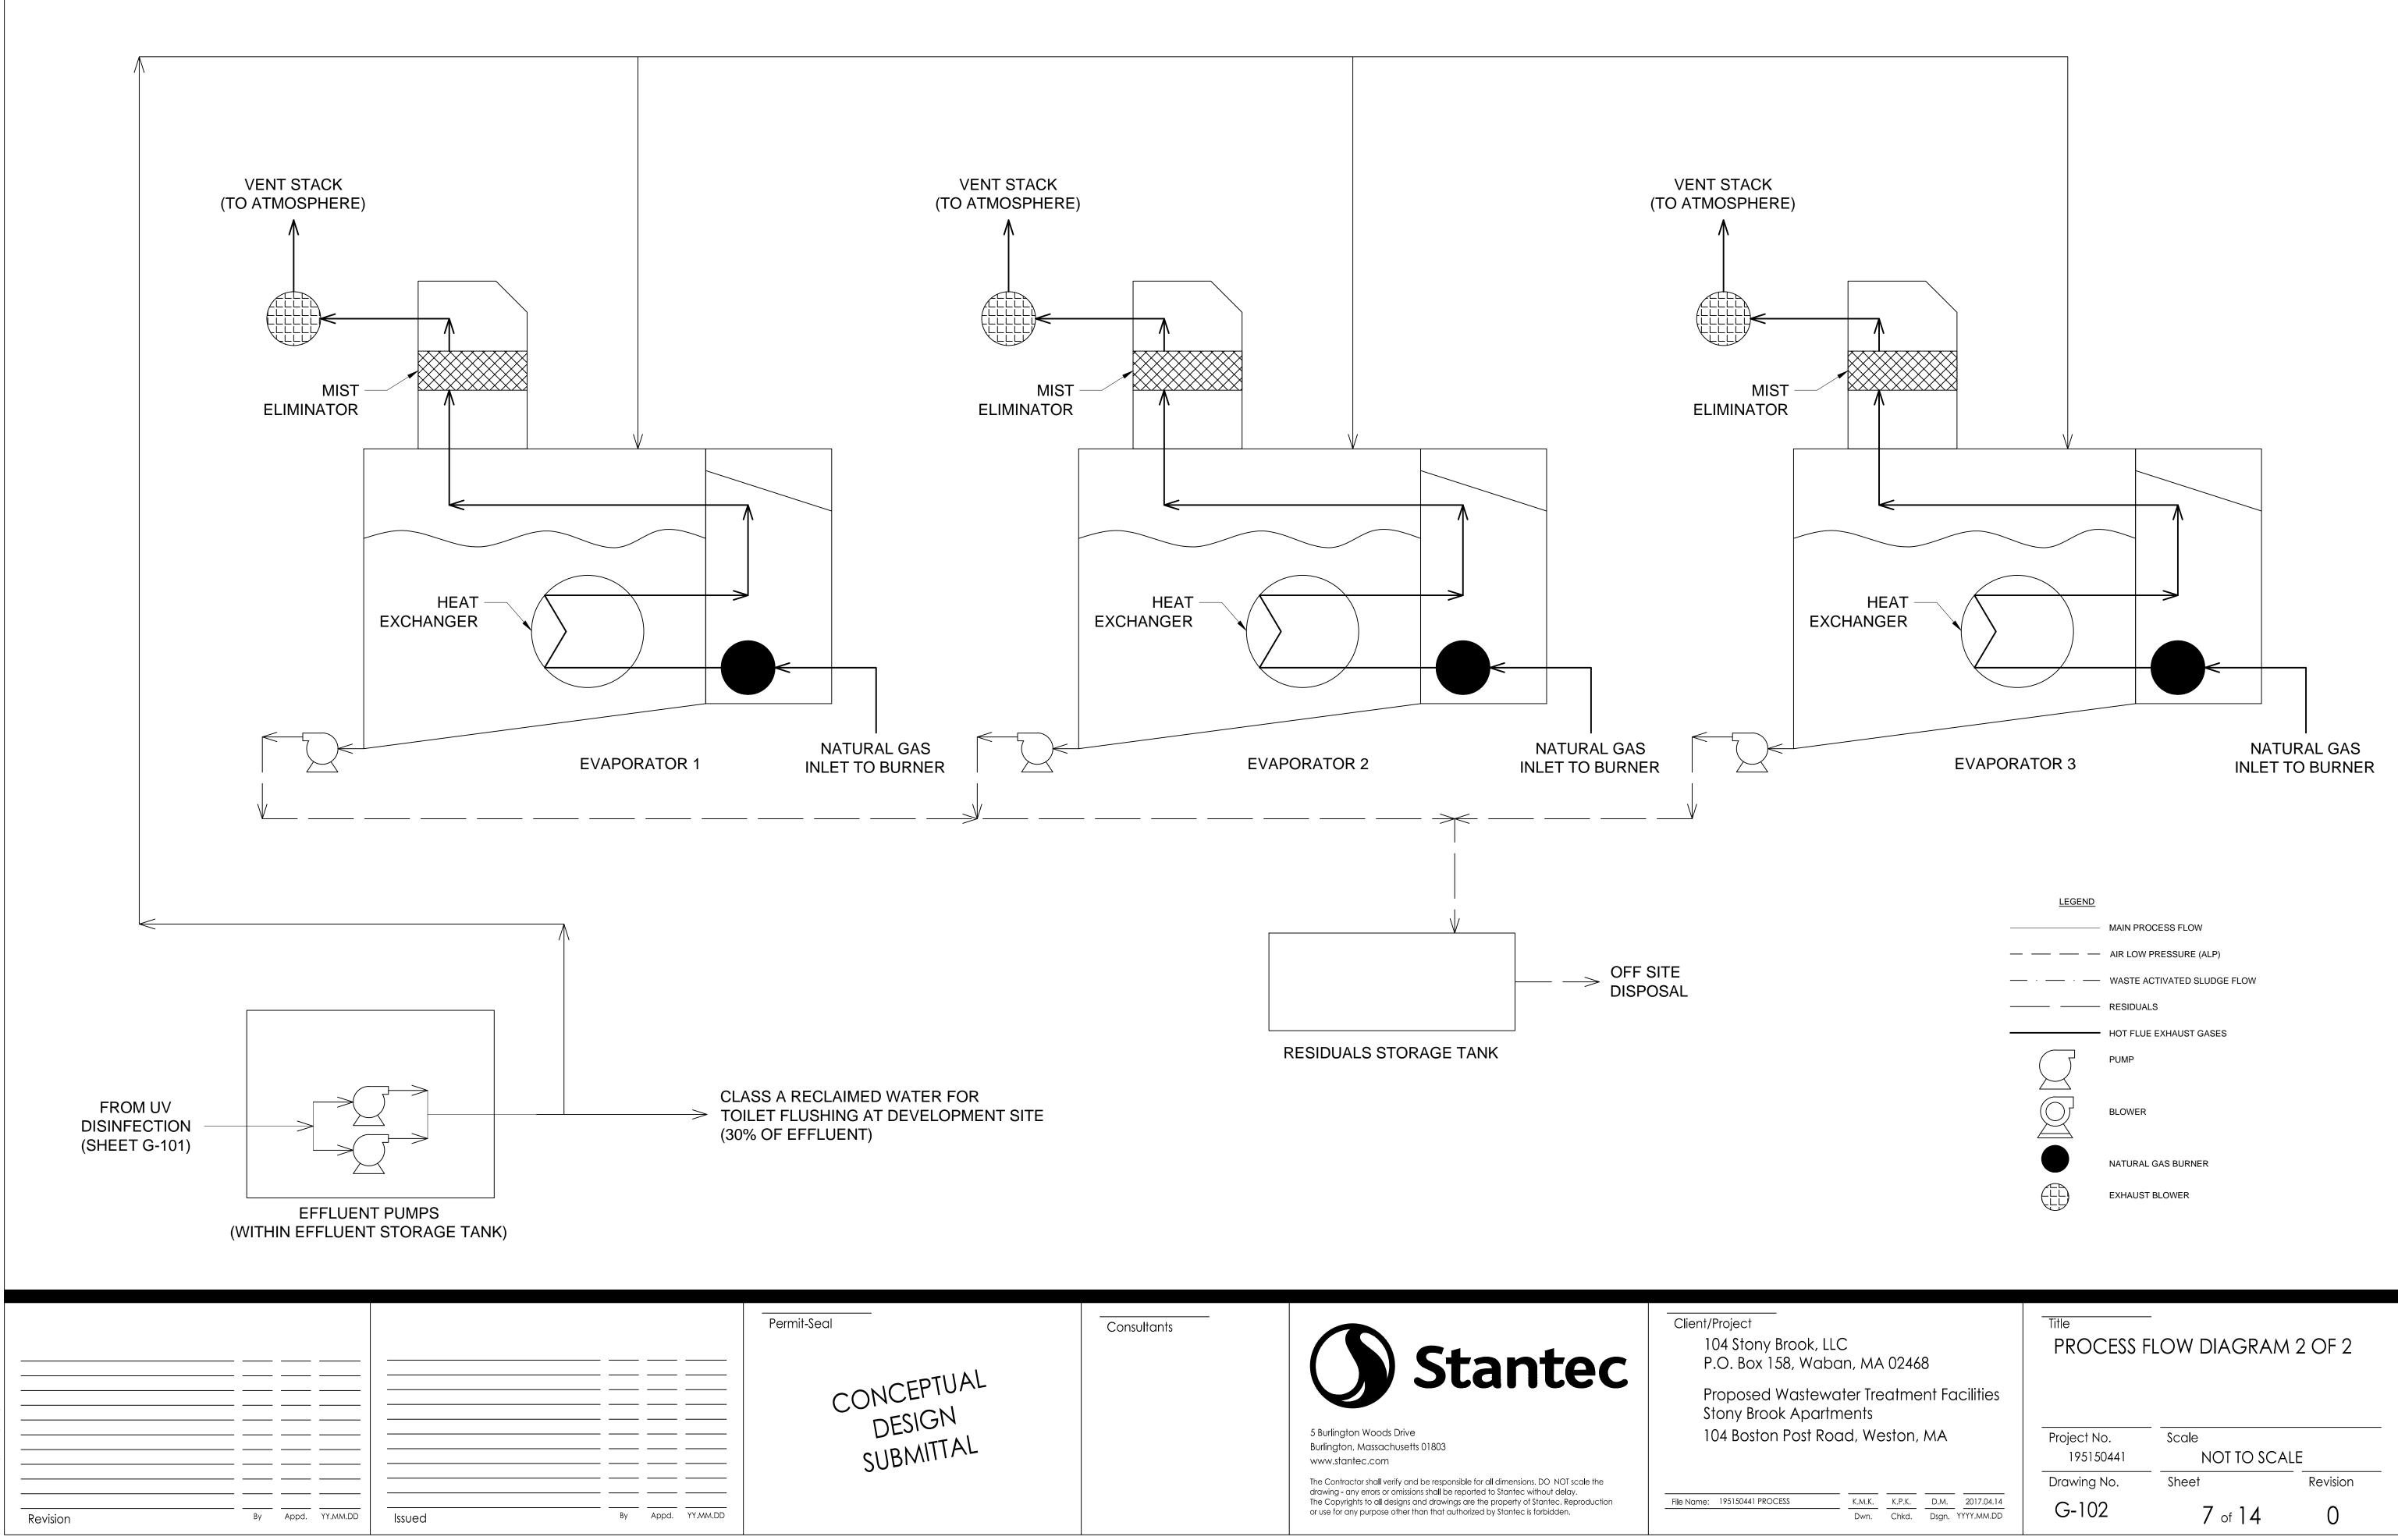



ORIGINAL SHEET - ANSI D

— ny Brook, LLC x 158, Waban, MA 02468	Title PROCESS F	- -LOW DIAGRAM	1 2 OF 2
ed Wastewater Treatment Facilities rook Apartments ton Post Road, Weston, MA	Project No. 195150441	- Scale NOT TO SCA	
	Drawing No.	Sheet	Revision
PROCESS K.M.K. K.P.K. D.M. 2017.04.14 Dwn. Chkd. Dsgn. YYYY.MM.DD	G-102	7 of 14	0

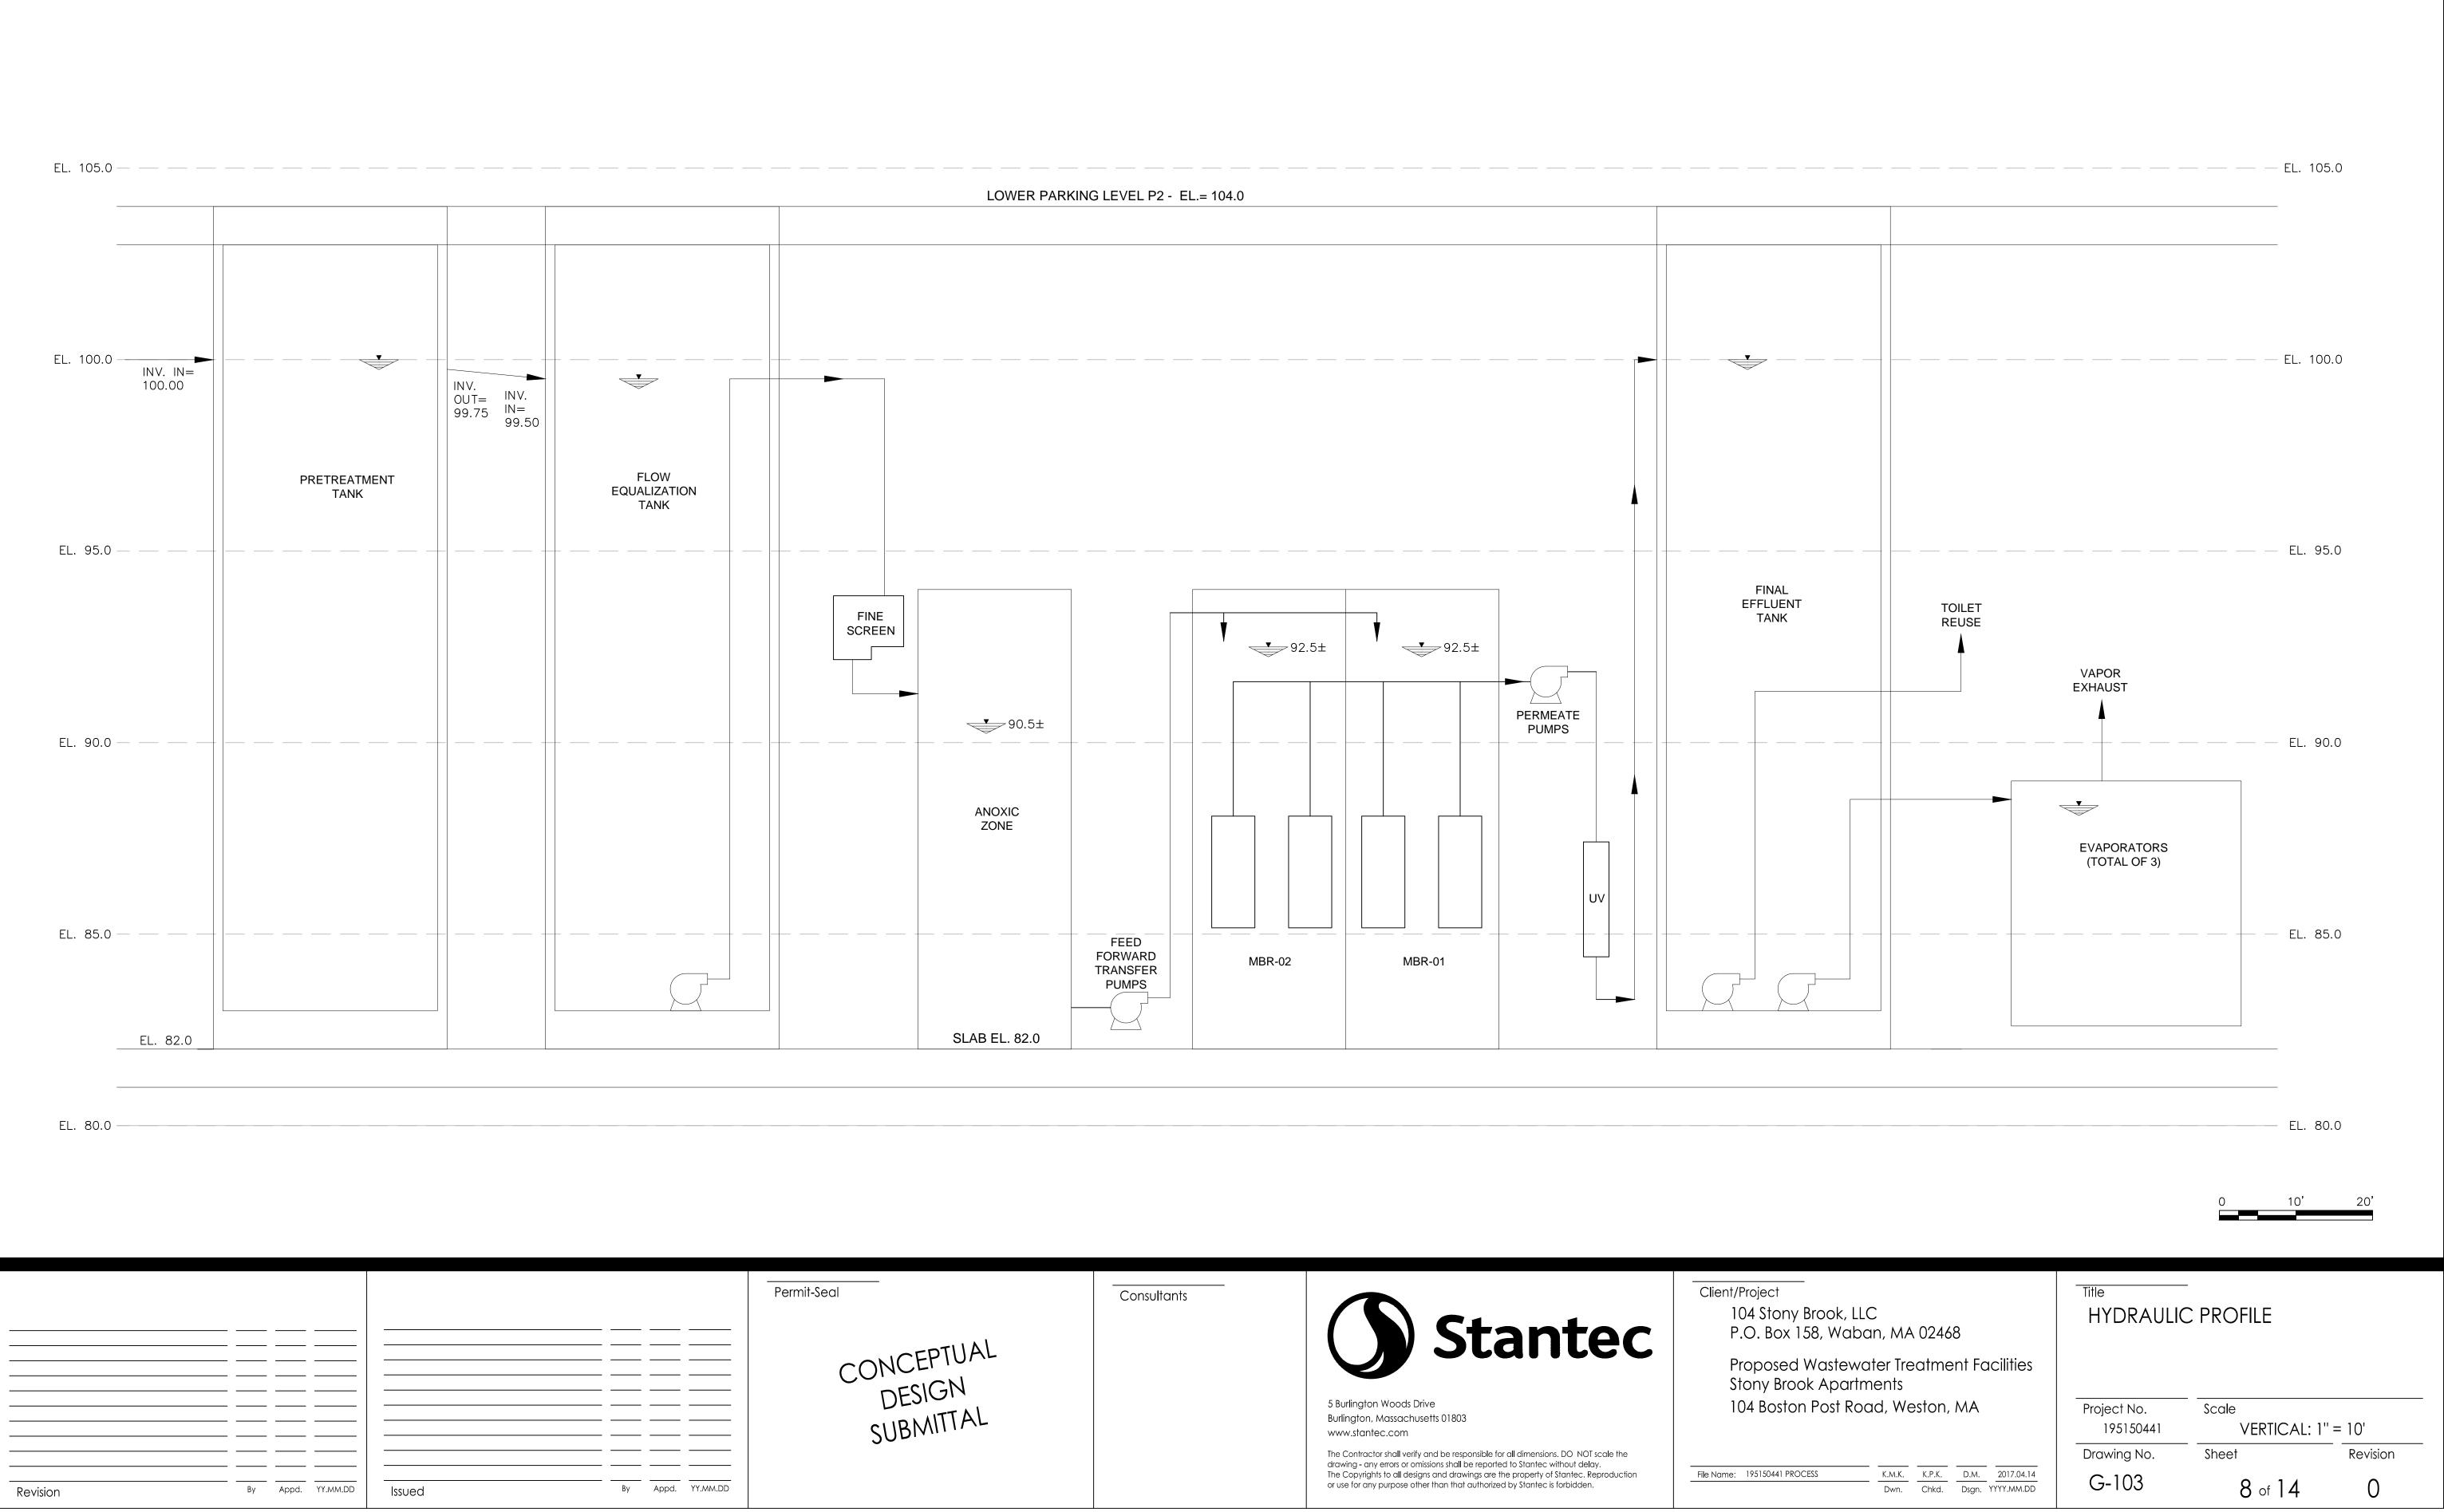

ORIGINAL SHEET - ANSI D

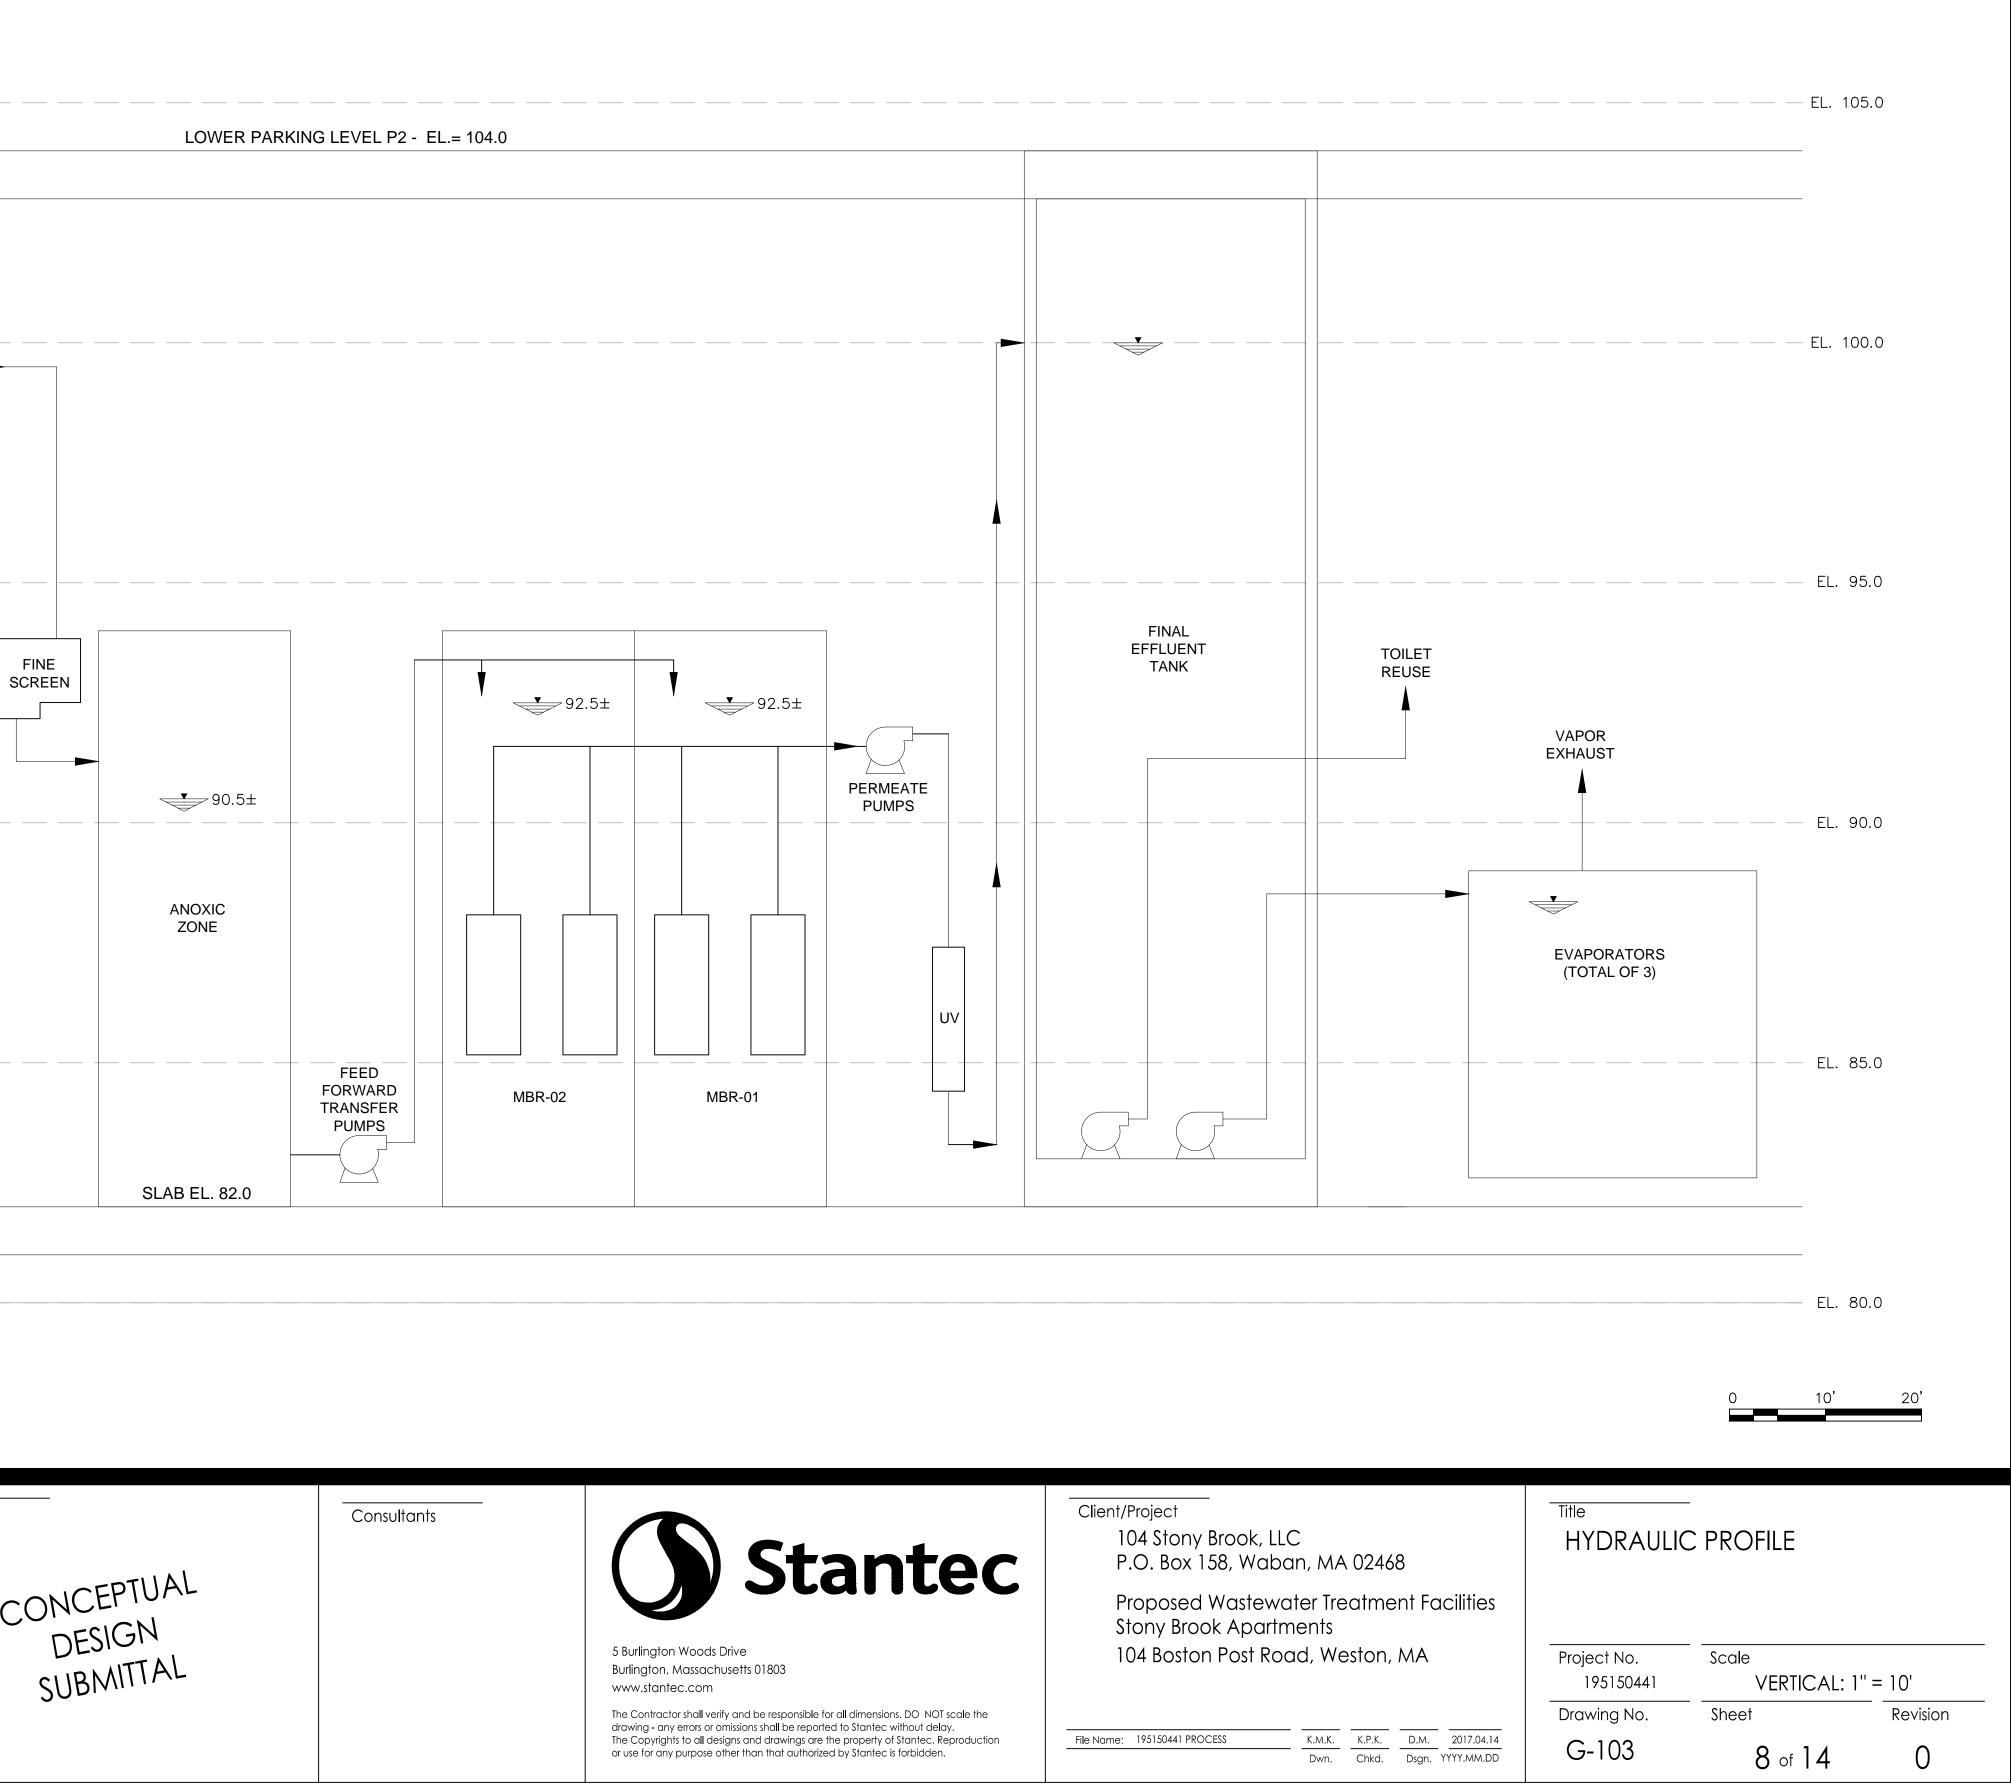

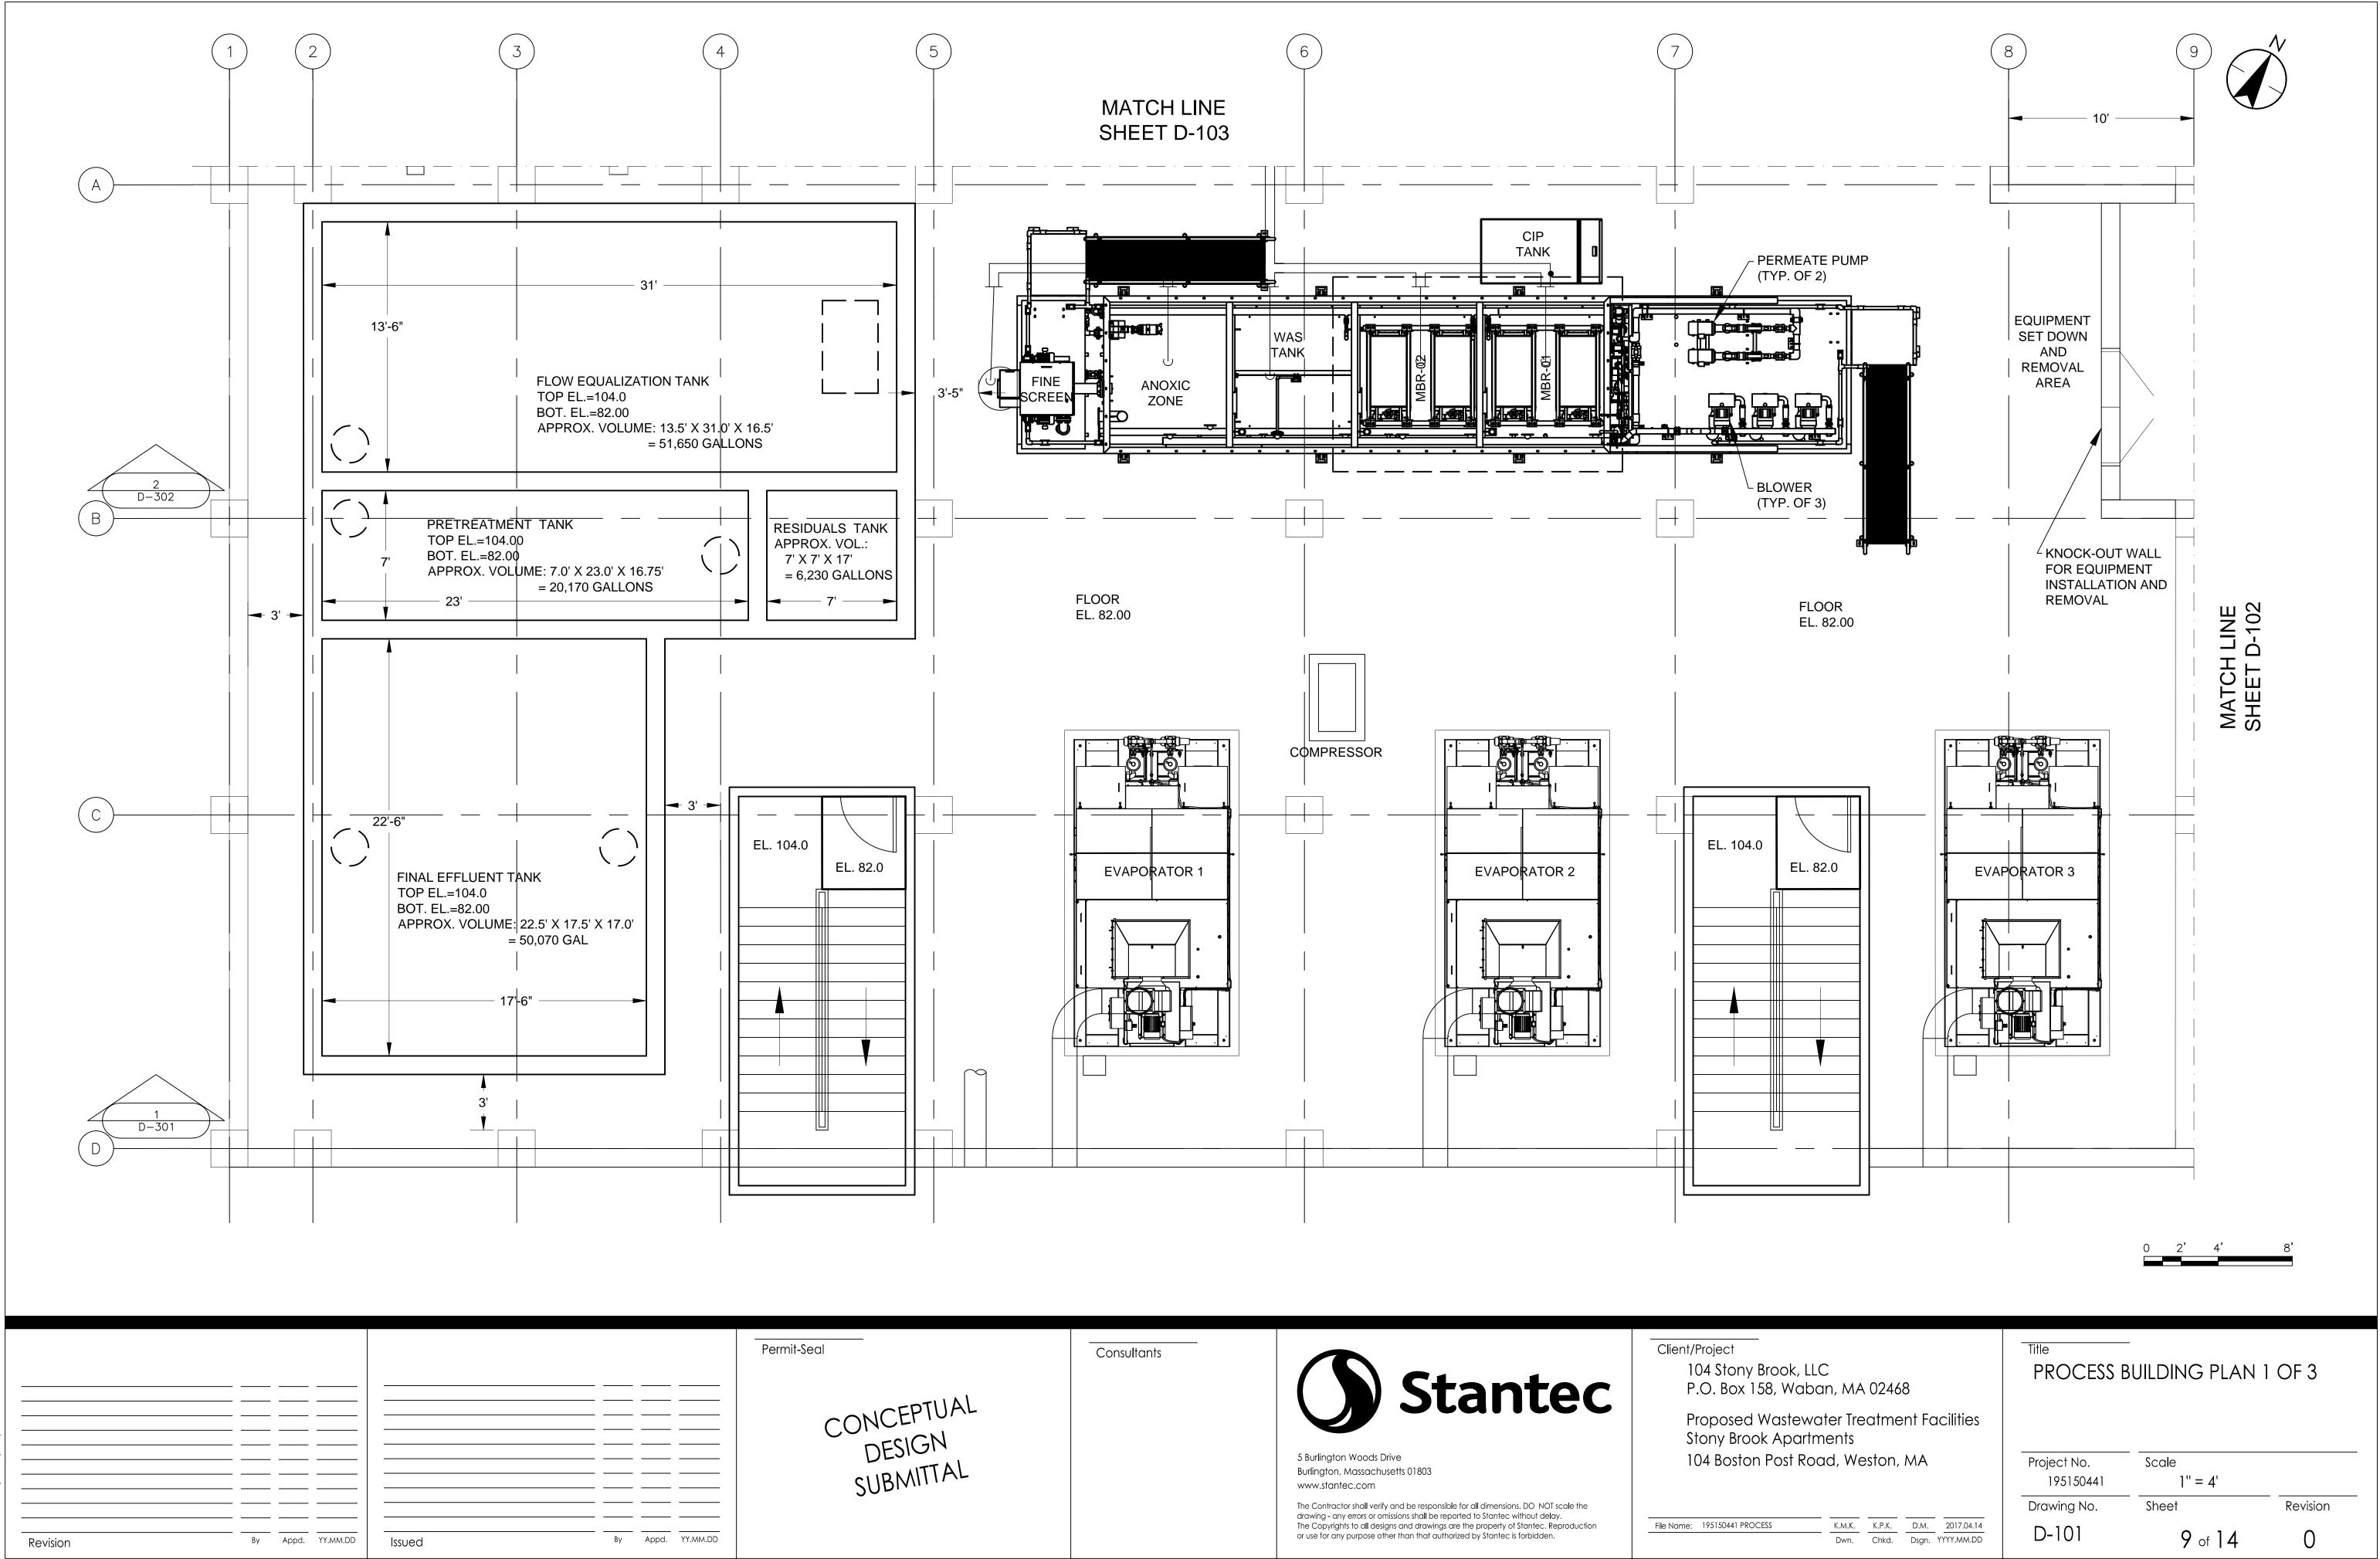




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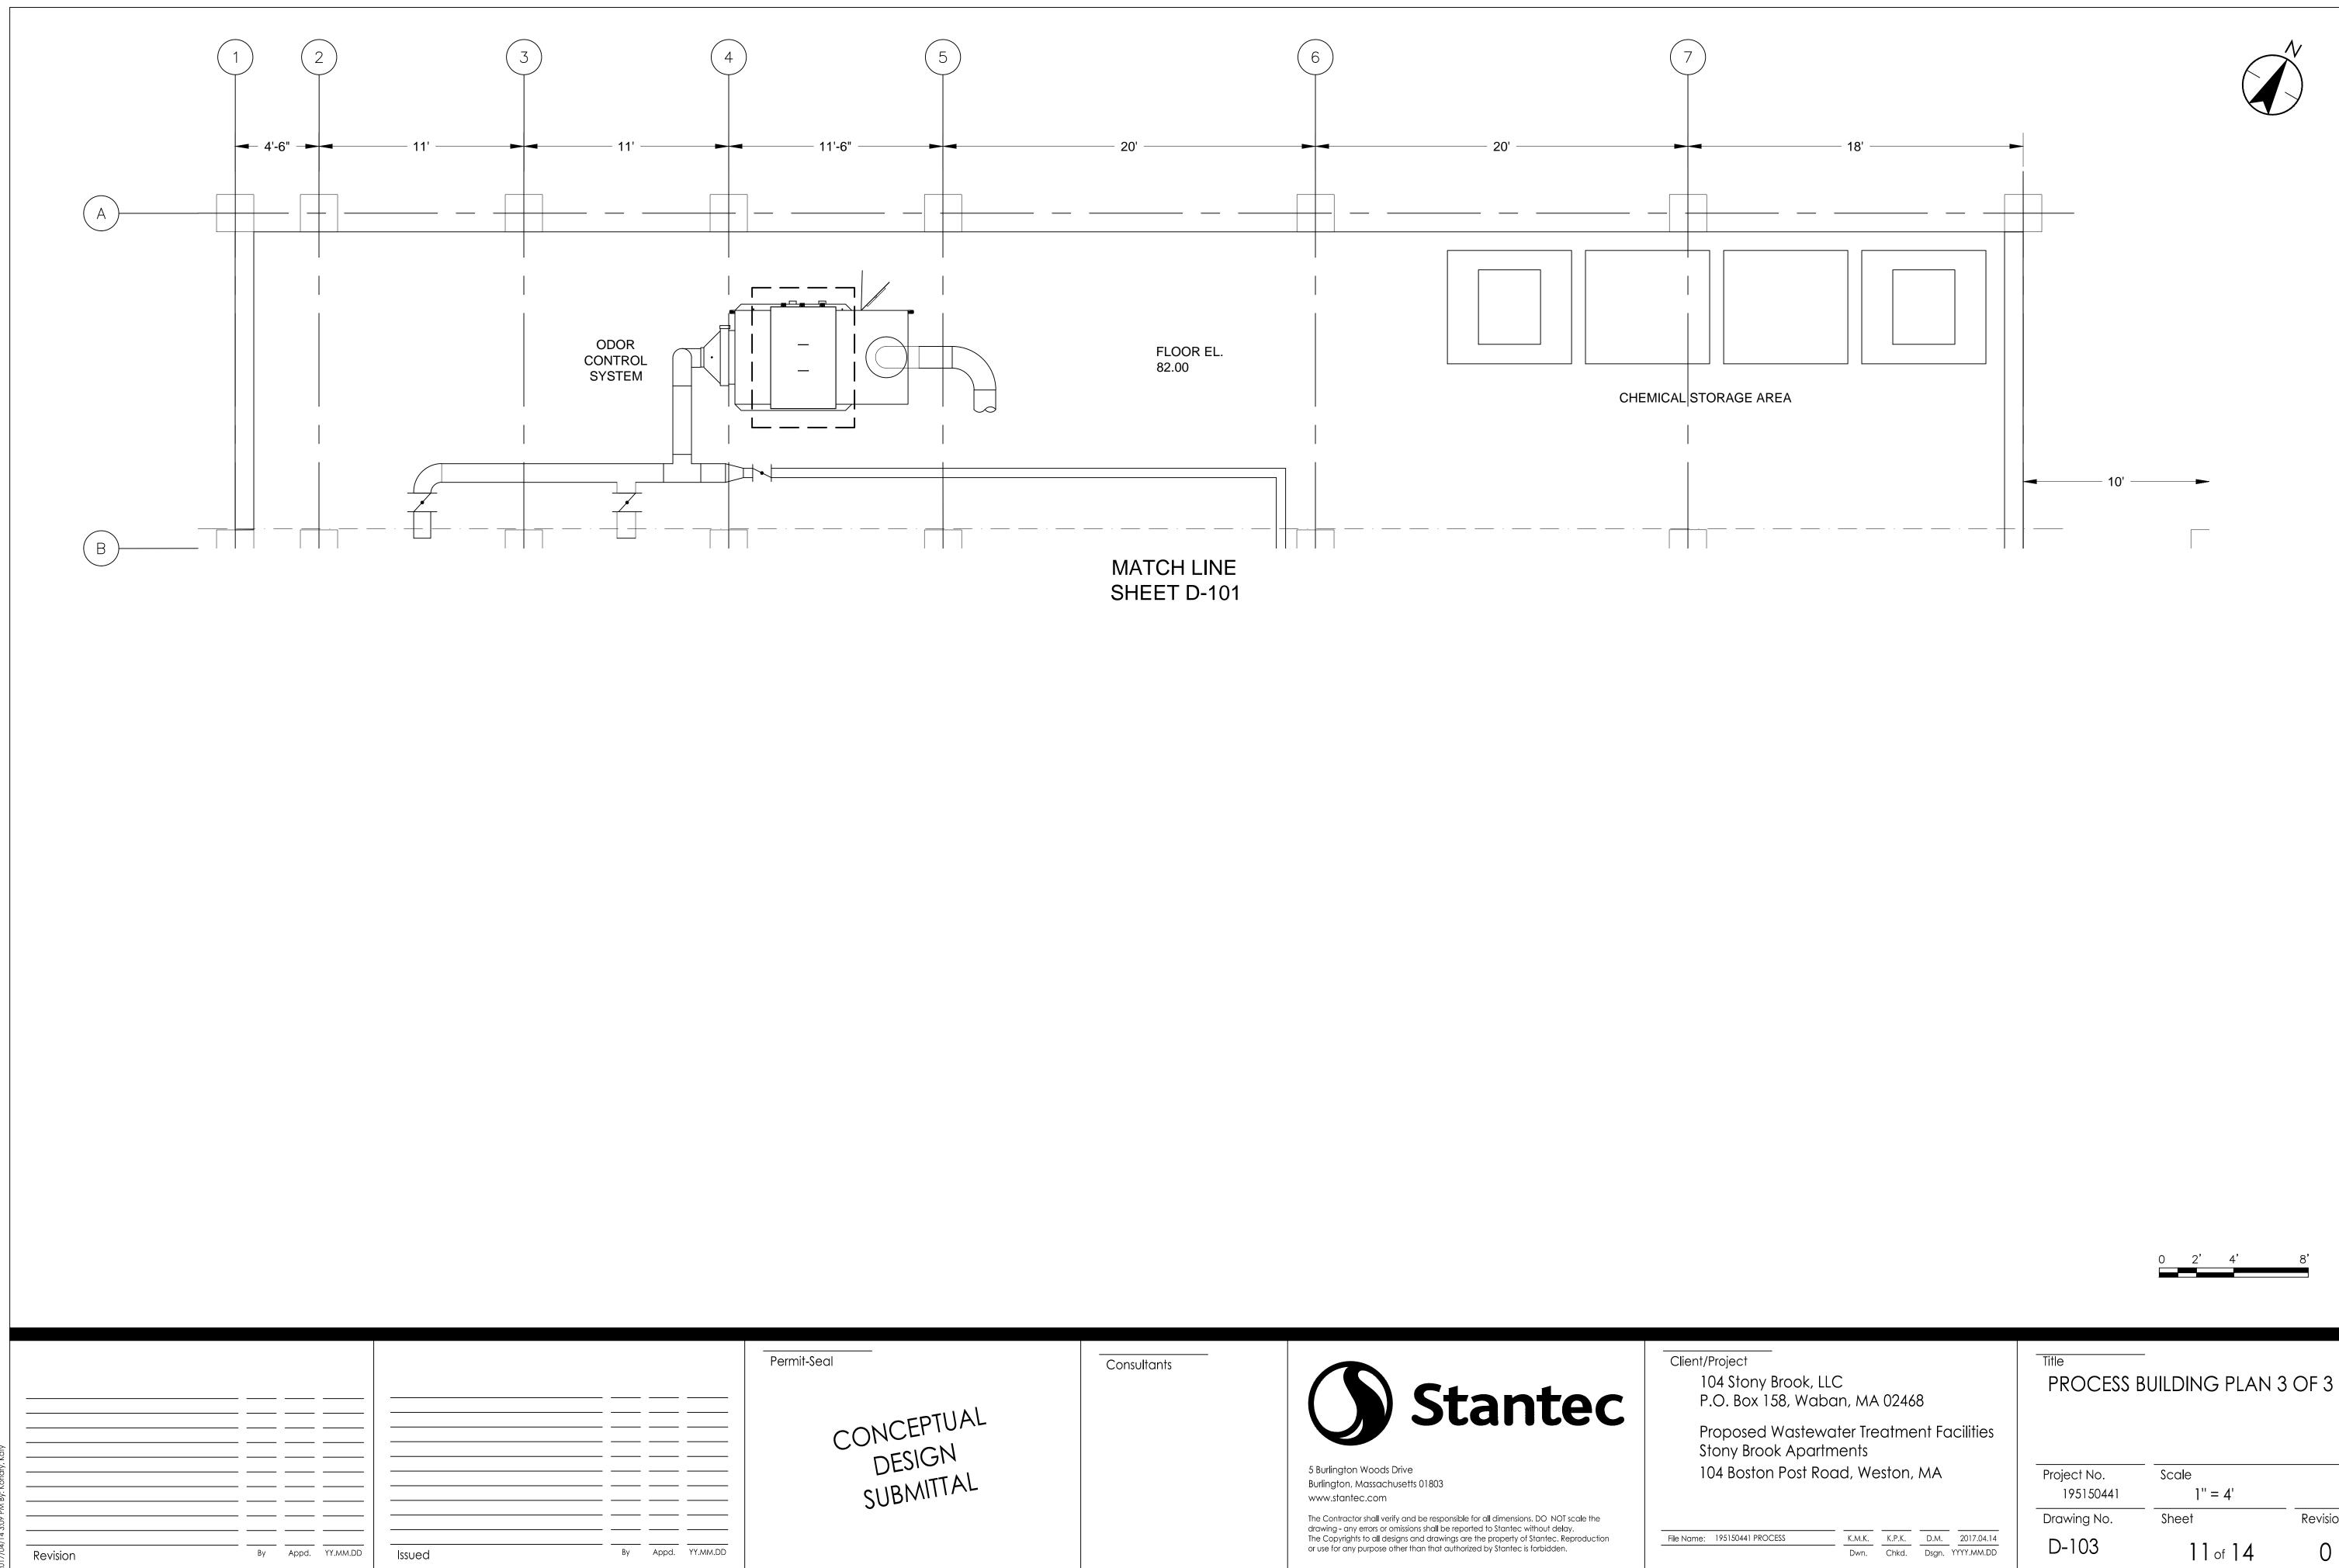
CONCEPTUAL DESIGN	Consultants	<b>Stantec</b>	Client/Project 104 Ston P.O. Box Proposed Stony Brc
SUBMITTAL		5 Burlington Woods Drive Burlington, Massachusetts 01803 www.stantec.com The Contractor shall verify and be responsible for all dimensions. DO NOT scale the drawing - any errors or omissions shall be reported to Stantec without delay. The Copyrights to all designs and drawings are the property of Stantec. Reproduction or use for any purpose other than that authorized by Stantec is forbidden.	104 Bostc

	FLOOR EL. SET 82.00 AND R		1 OUTSIDE FINISH GROUND EL. 94+/- 18' 16'	-B
	Permit-Seal	<u>Consultants</u>	18'	Client/Project 104 Stony Broo P.O. Box 158, V Proposed Was
Image: Second Wight Holds Image:	By Appd. YY.MM.DD	L	5 Burlington Woods Drive Burlington, Massachusetts 01803 www.stantec.com The Contractor shall verify and be responsible for all dimensions. DO NOT sca drawing - any errors or omissions shall be reported to Stantec without delay. The Copyrights to all designs and drawings are the property of Stantec. Repro or use for any purpose other than that authorized by Stantec is forbidden.	Proposed Was Stony Brook Ap 104 Boston Pos oduction File Name: 195150441 PROCESS



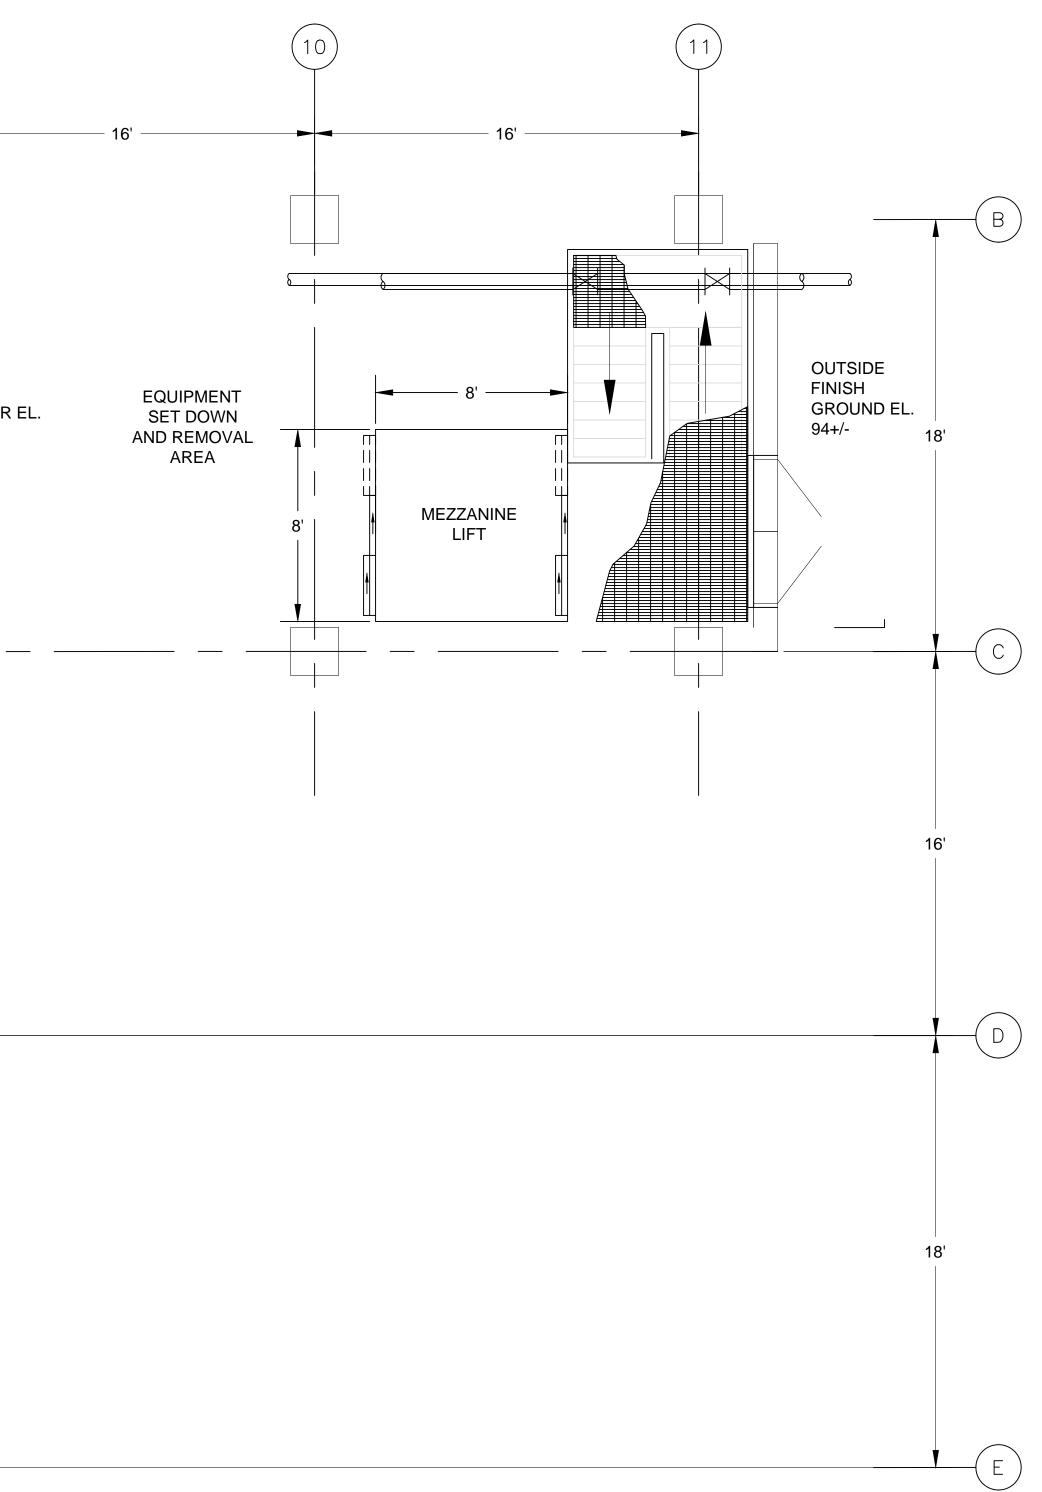



		0 2' 4'	8'
ok, LLC Waban, MA 02468	Title PROCESS E	- Building Plan	2 OF 3
stewater Treatment Facilities partments ost Road, Weston, MA	Project No. 195150441	Scale 1'' = 4'	
	Drawing No.	Sheet	Revision
K.M.K.   K.P.K.   D.M.   2017.04.14     Dwn.   Chkd.   Dsgn.   YYYY.MM.DD	D-102	10 of 14	0




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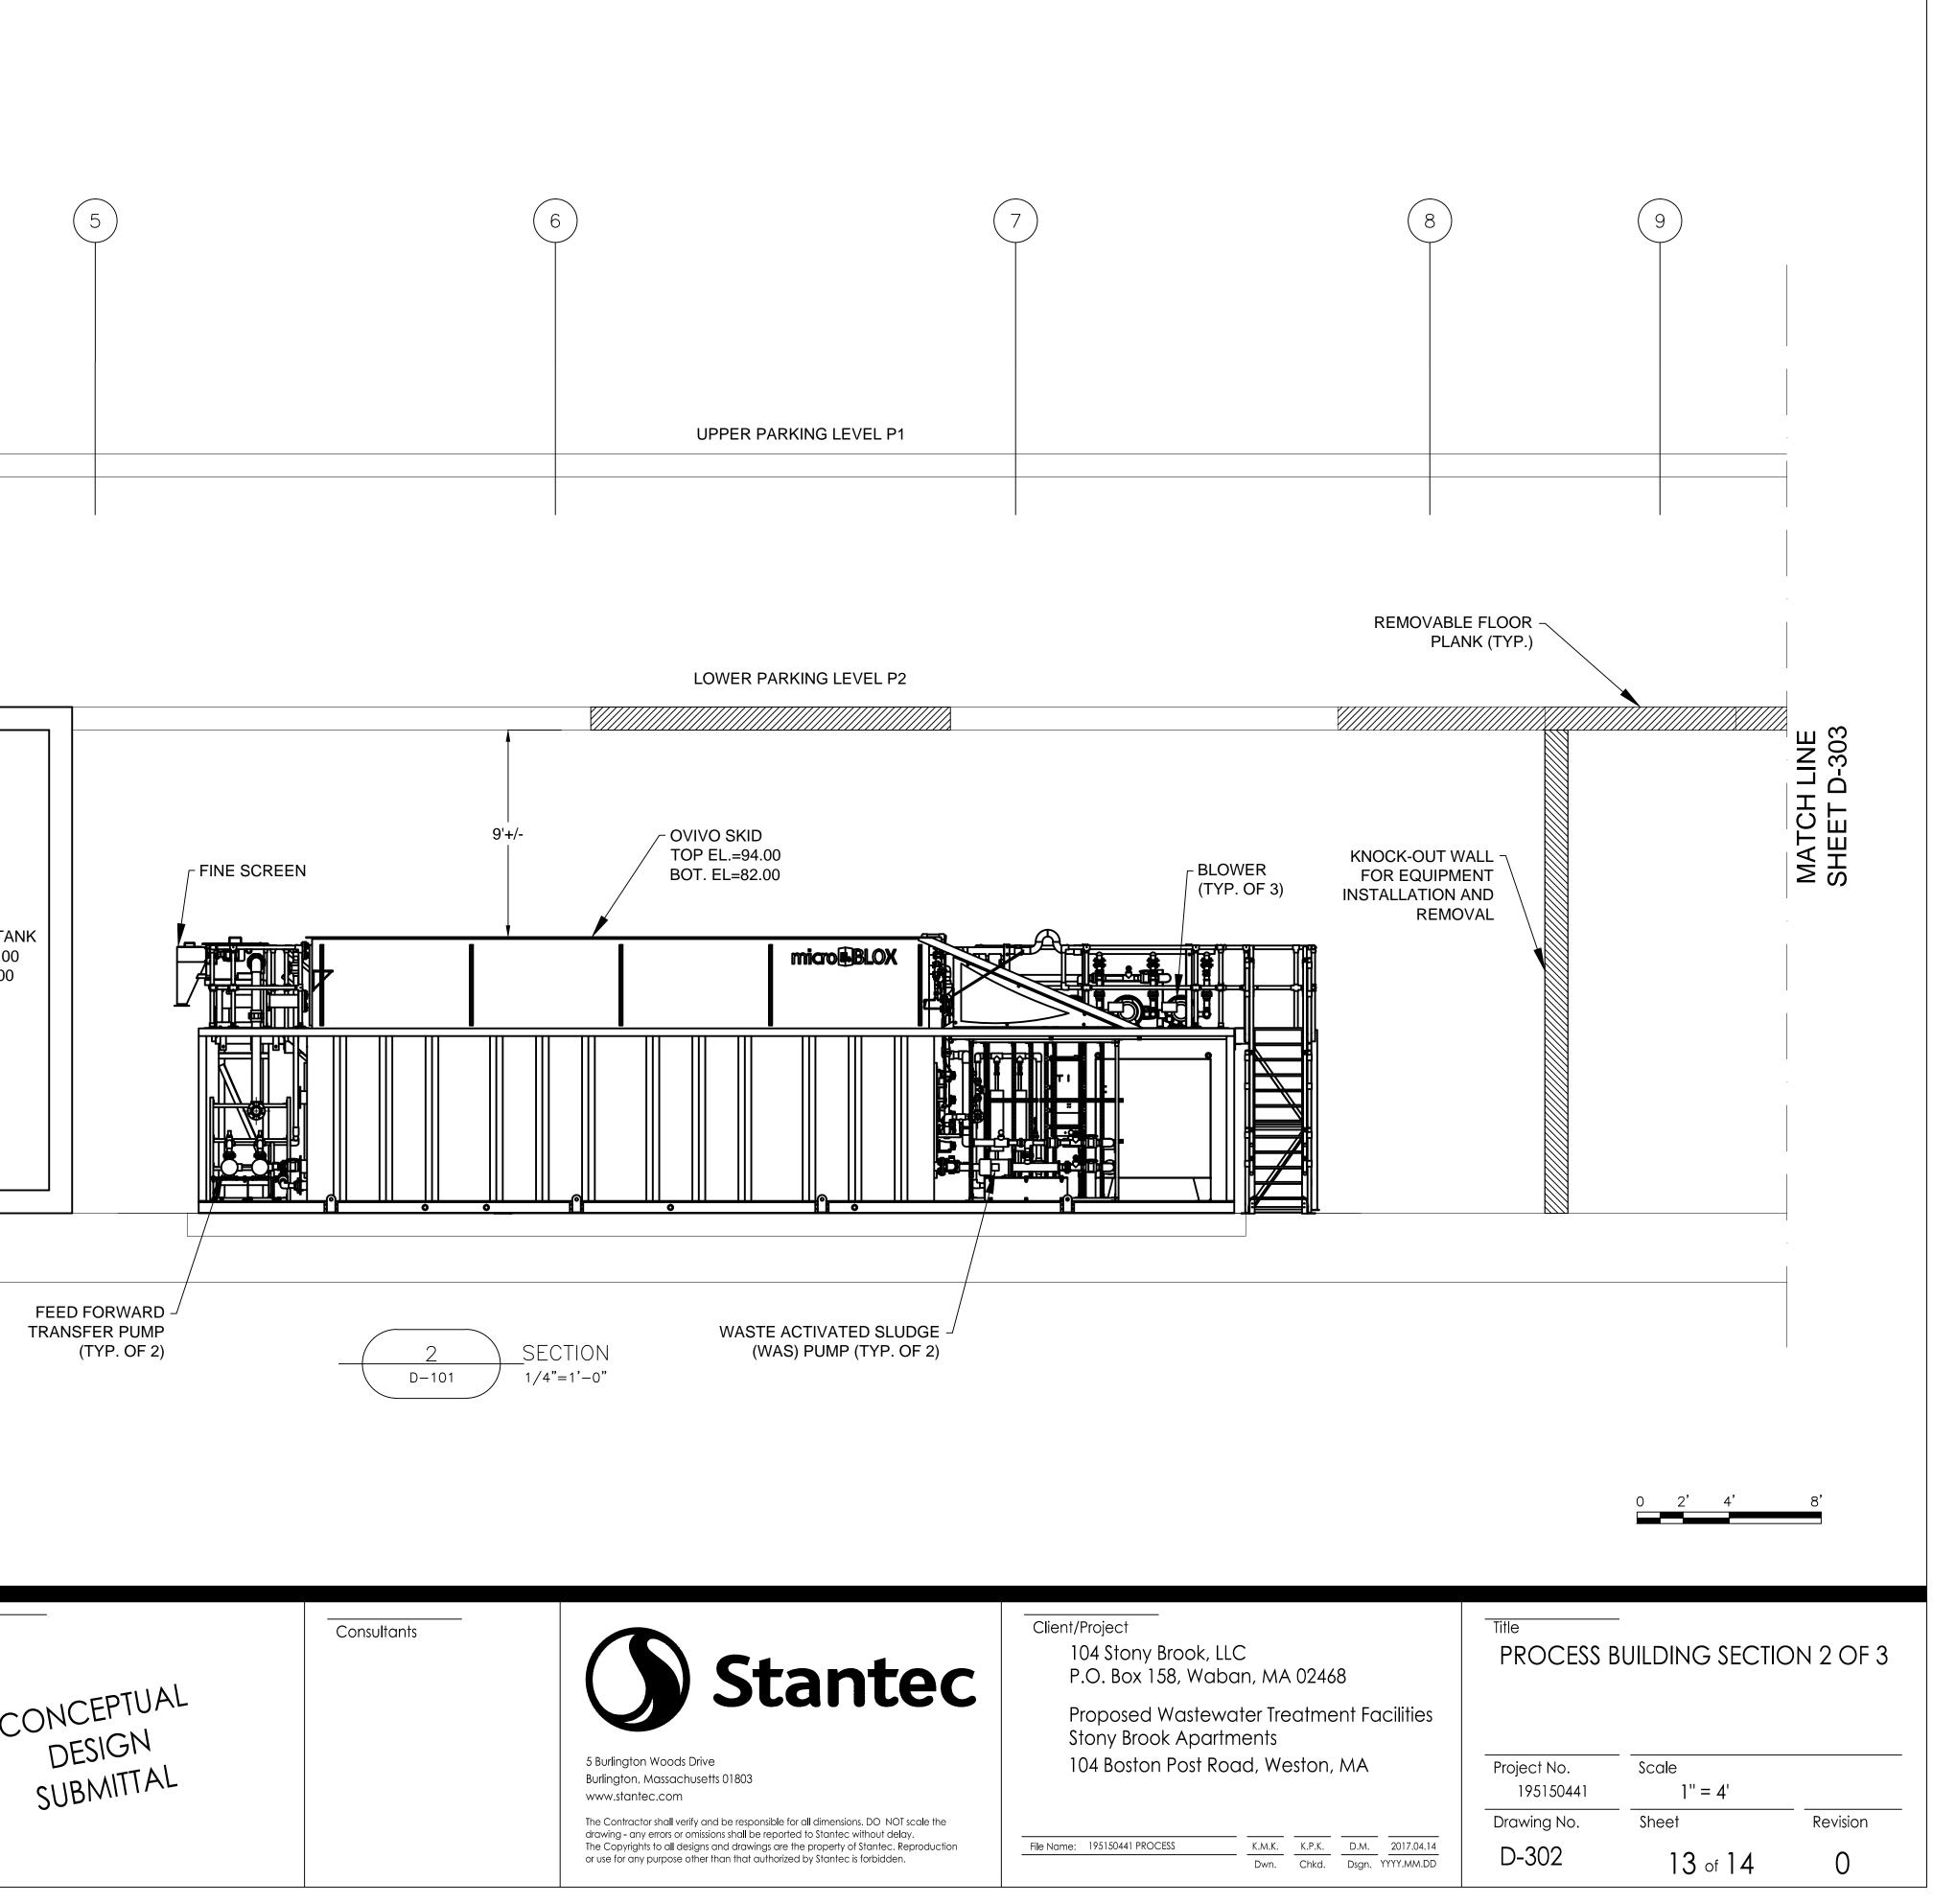
CONCEPTUAL DESIGN SUBMITTAL	Consultants <b>Surfington Woods Drive</b> Burlington, Massachusetts 01803 www.stantec.com The Contractor shall verify and be responsible for all dimensions. DO NOT scale the drawing - any errors or omissions shall be reported to Stantec without delay. The Copyrights to all designs and drawings are the property of Stantec. Reproduction or use for any purpose other than that authorized by Stantec is forbidden.	<b>Stantec</b>	Client/Project 104 Stony Brook, LLC P.O. Box 158, Waban, MA 02468 Proposed Wastewater Treatment Facilities Stony Brook Apartments		Title PROCESS BUILDING PLAN 3 OF 3		
		104 Boston Post Road, Weston, MA	Project No. 195150441	Scale ]'' = 4'			
			Drawing No.	Sheet	Revision		
		The Copyrights to all designs and drawings are the property of Stantec. Reproduction	File Name:   195150441 PROCESS   K.M.K.   K.P.K.   D.M.   2017.04.14     Dwn.   Chkd.   Dsgn.   YYYY.MM.DD	D-103	<b>]]</b> of <b>]4</b>	0	



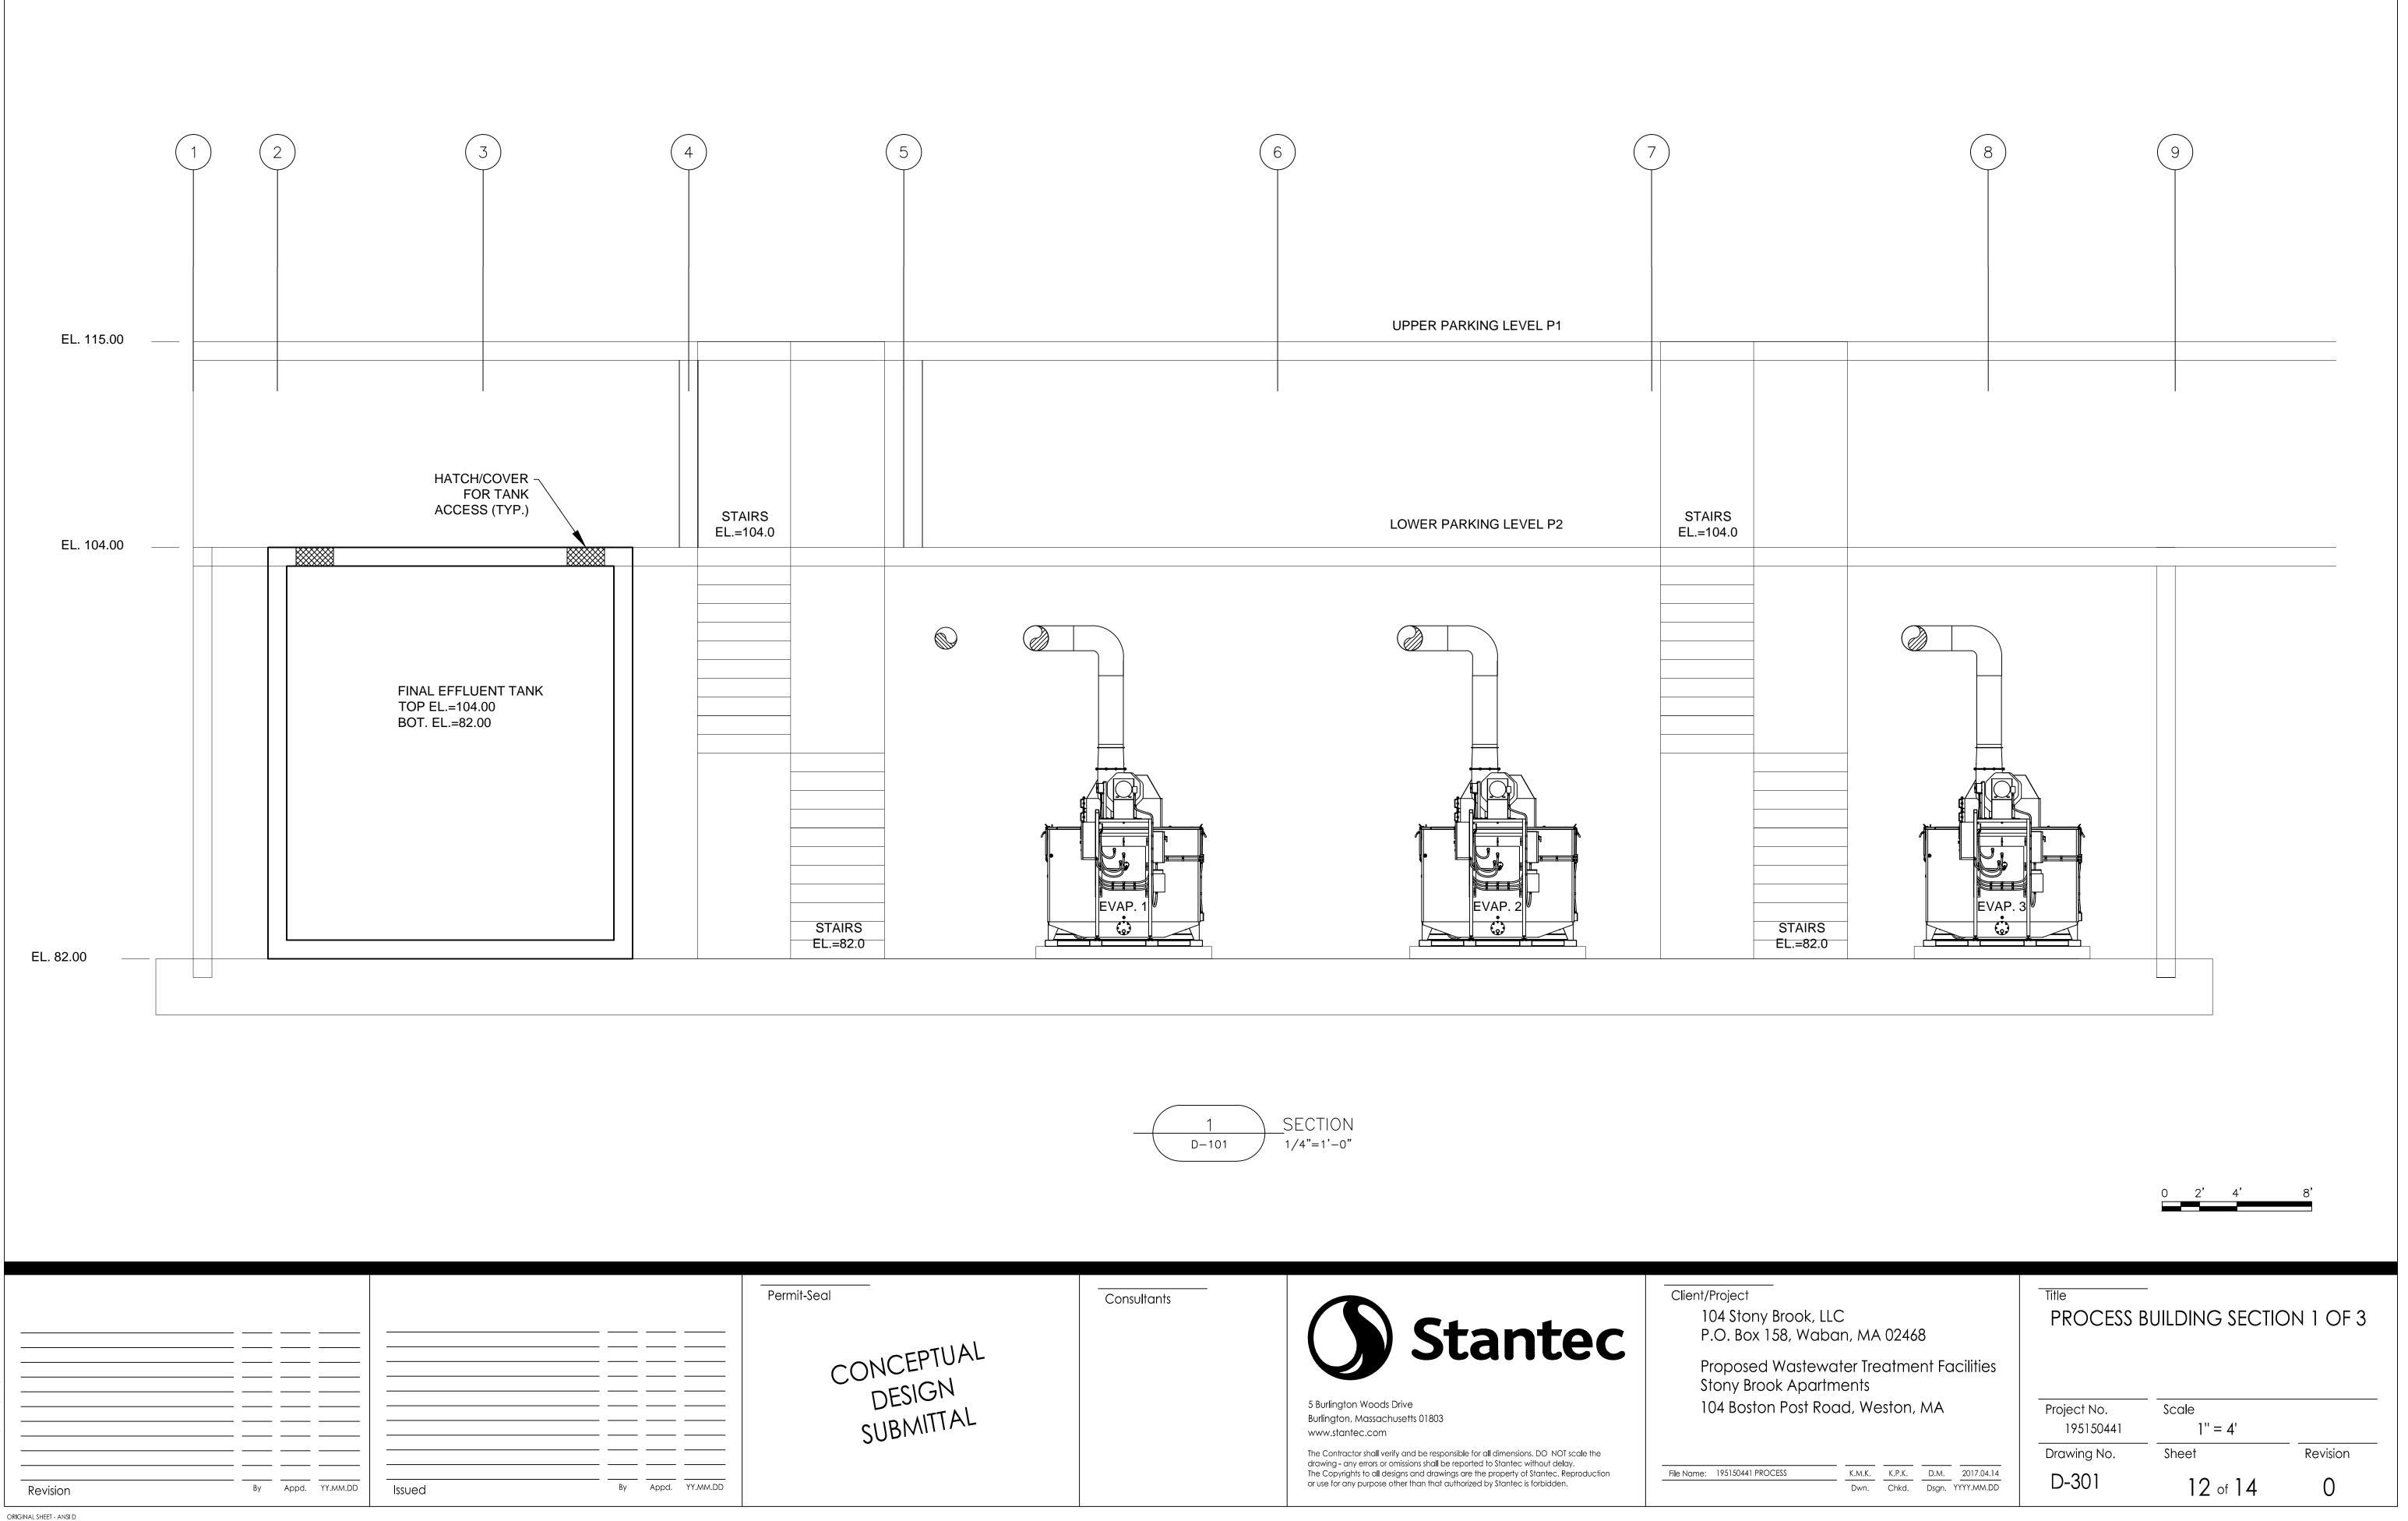

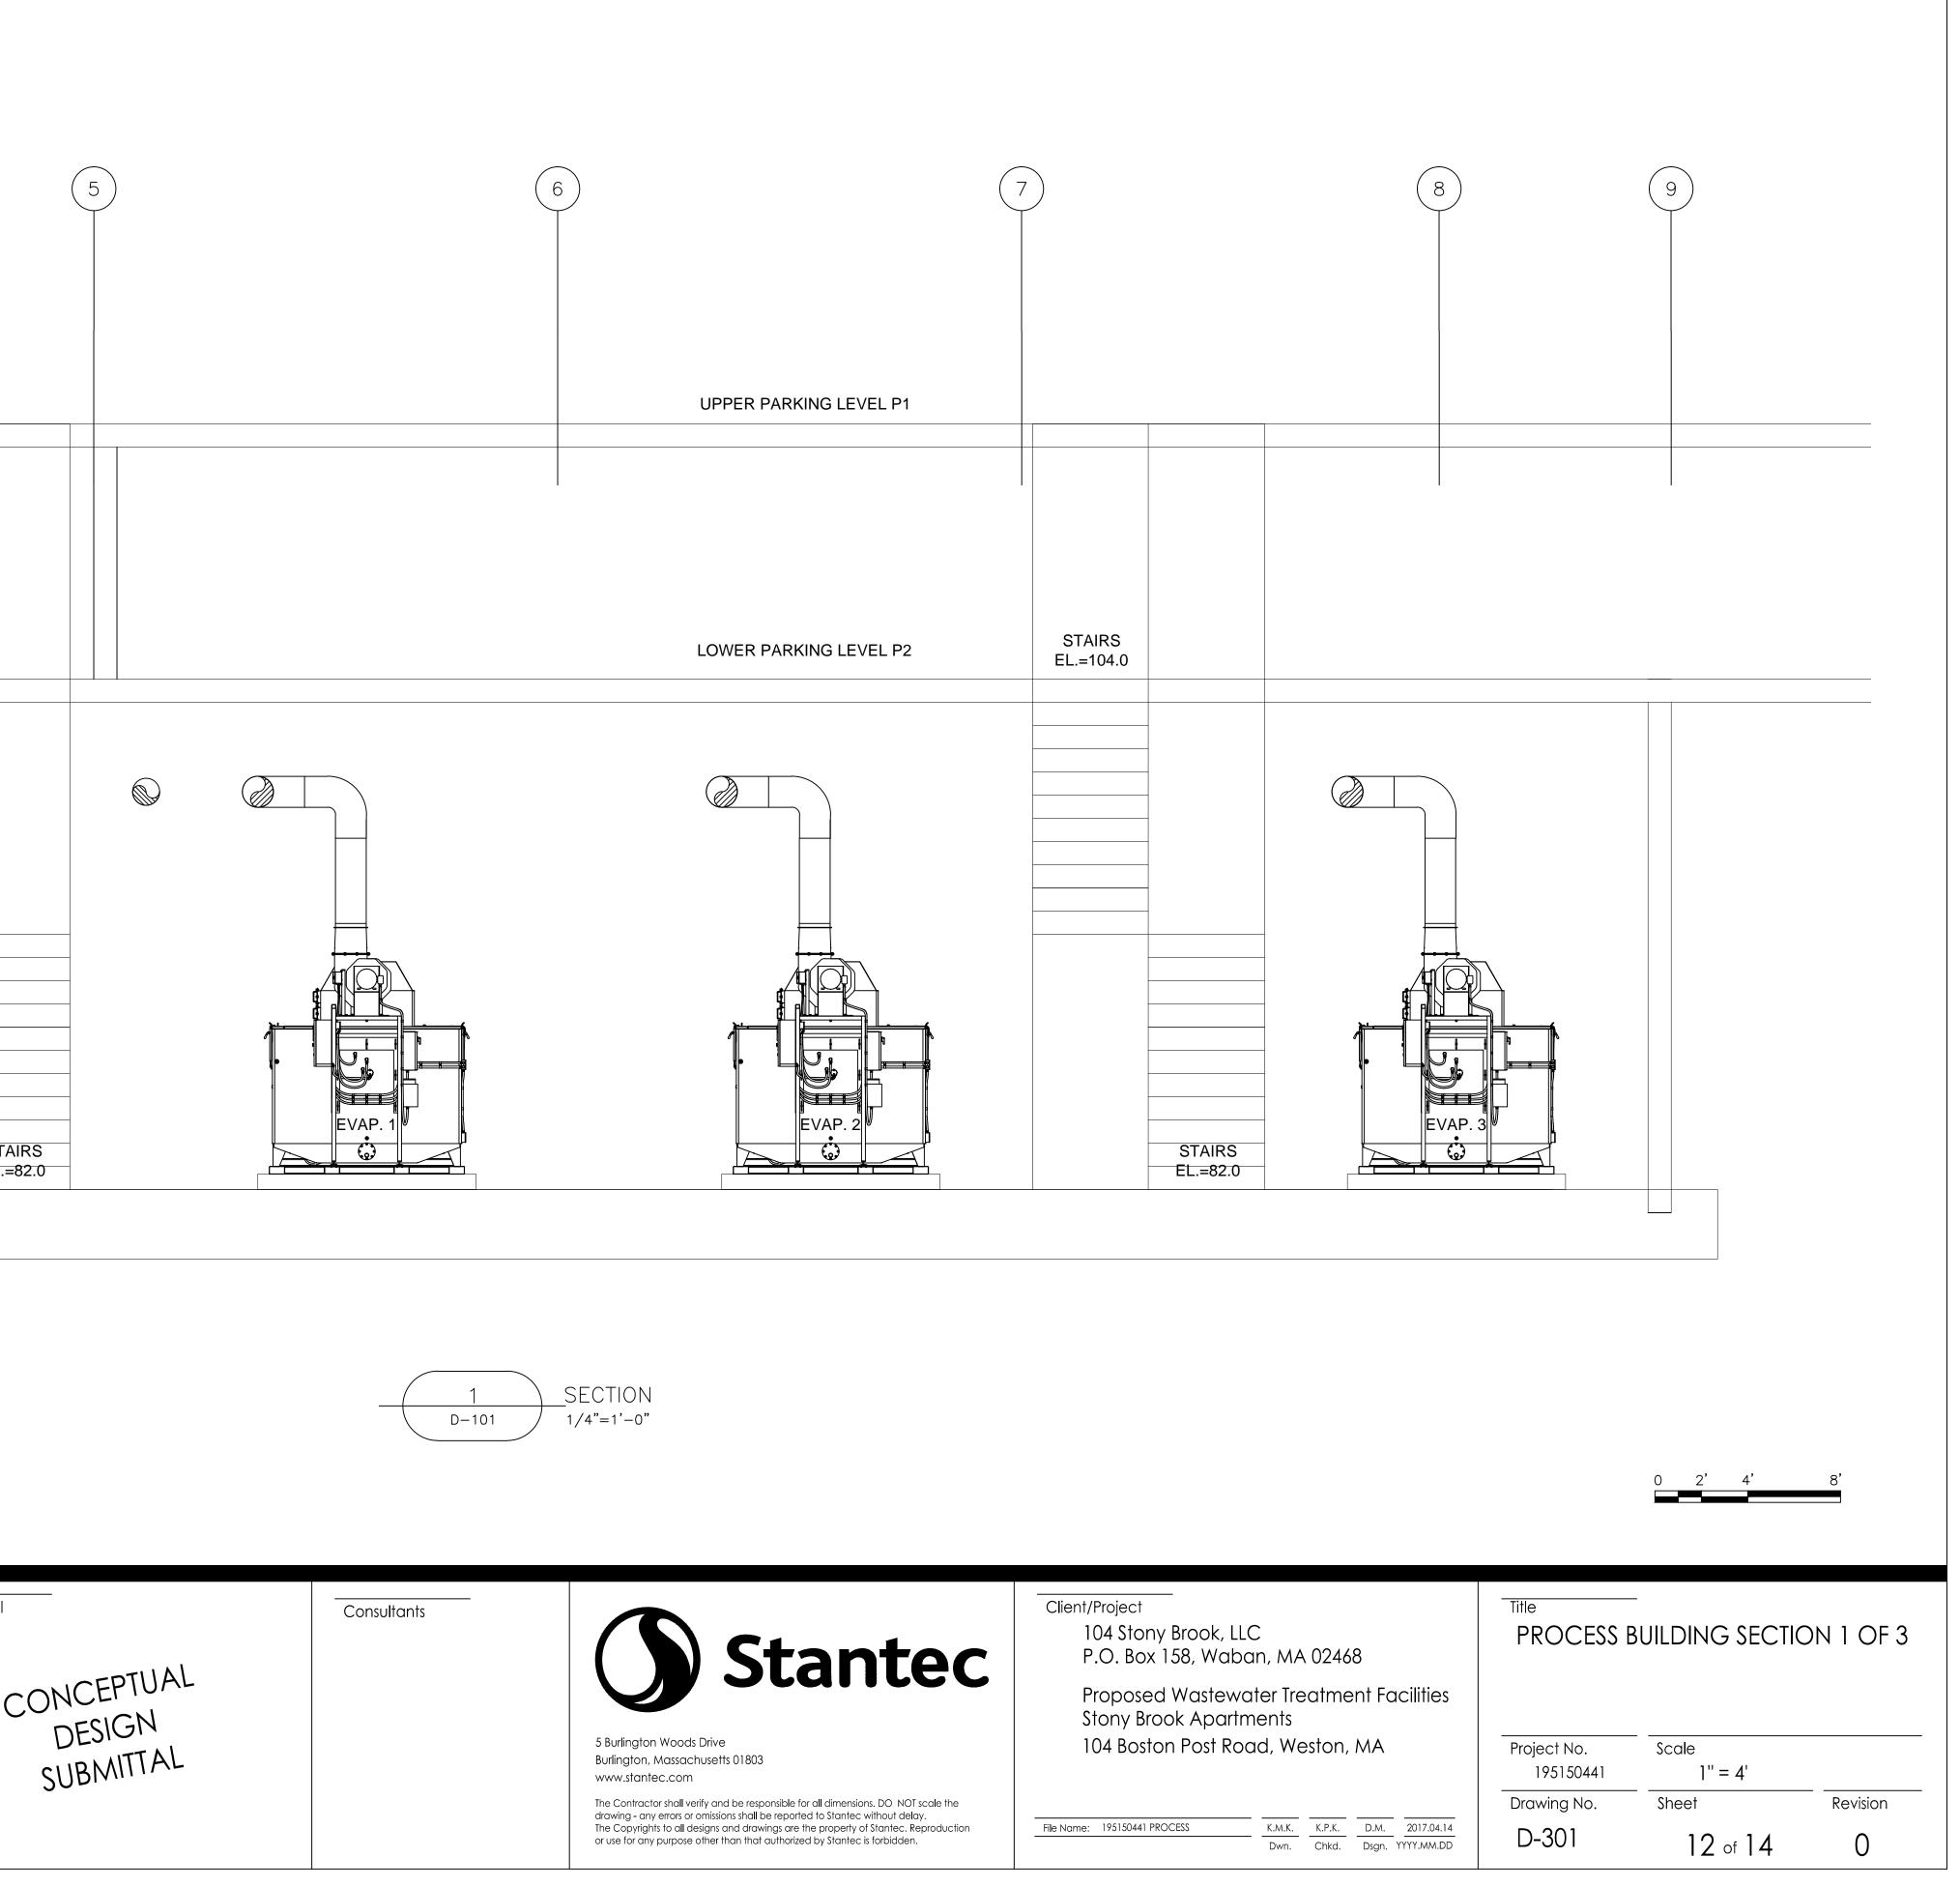

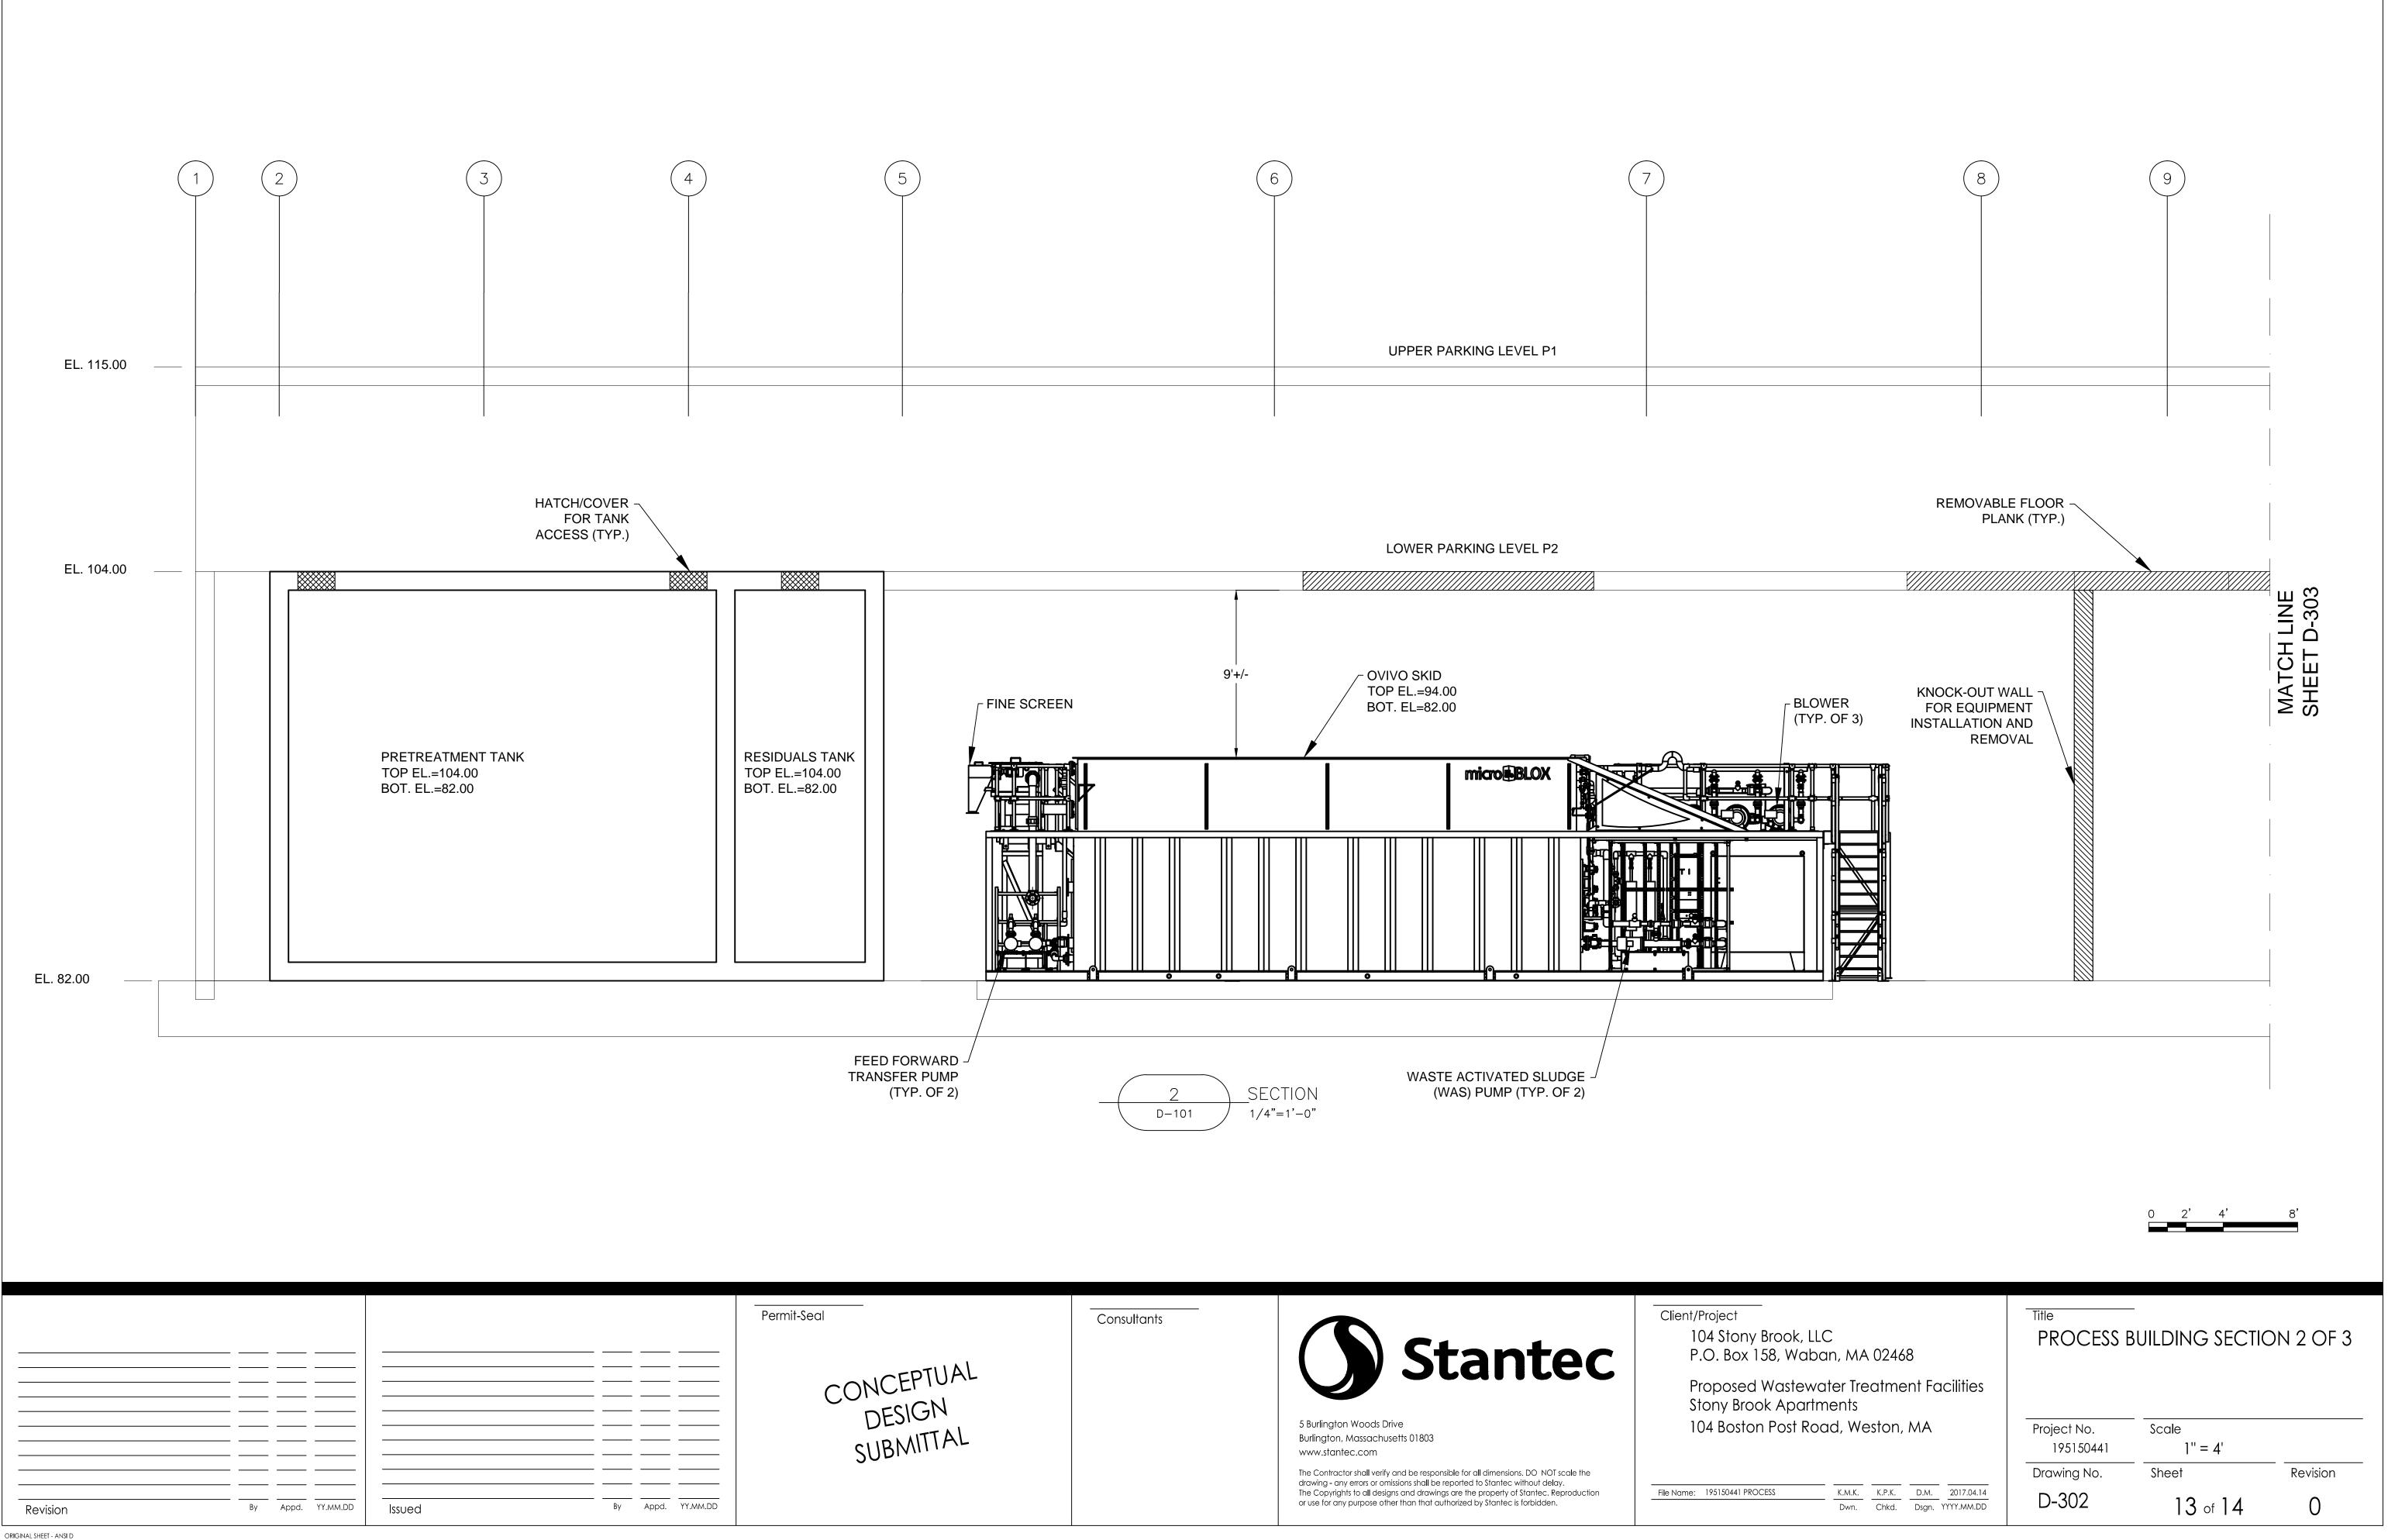	UPPER PARKING LEVEL P1	



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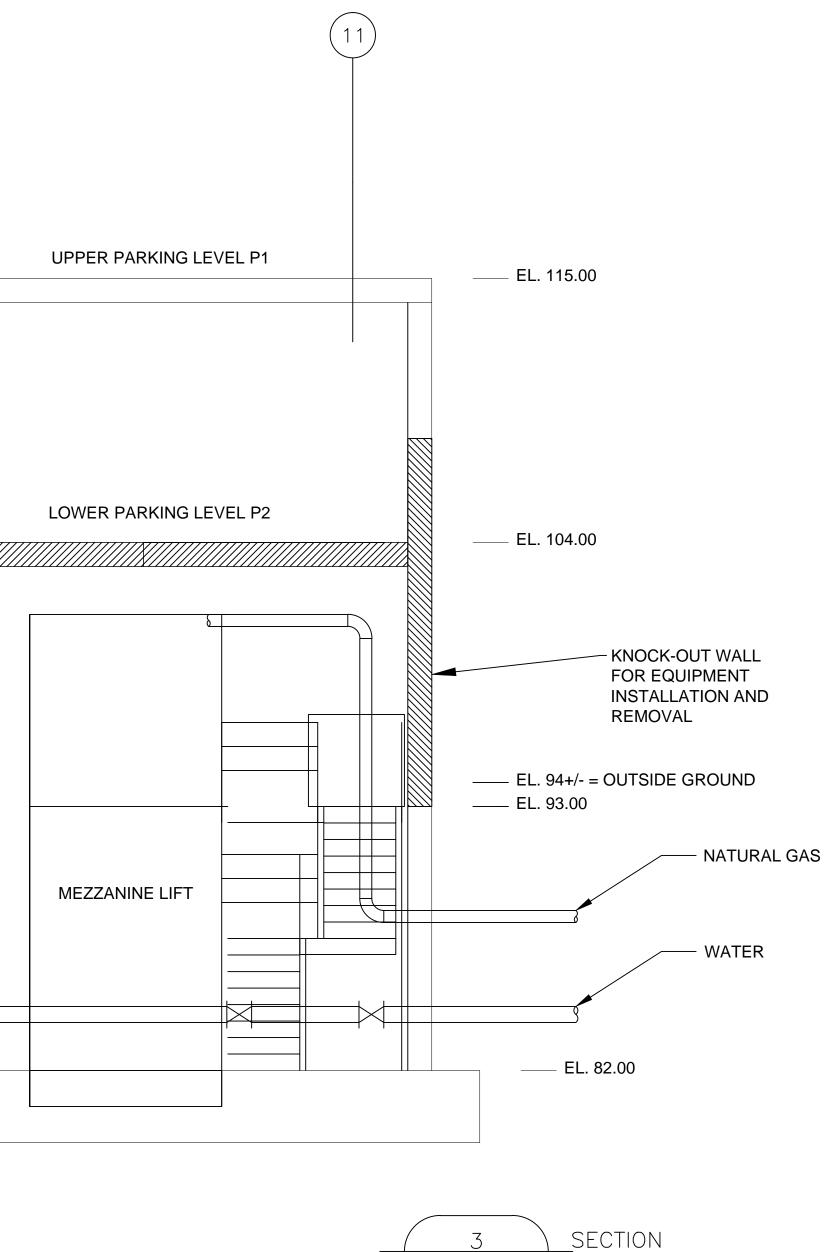
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Issued

By Appd. YY.MM.DD

ORIGINAL SHEET - ANSI D

Revision





1/4"=1'-0"

D-102

ook, LLC 8, Waban, MA 02468	Title PROCESS B	Building Section	DN 3 OF 3	
astewater Treatment Facilities Apartments Post Road, Weston, MA	Project No. 195150441			
K.M.K. K.P.K. D.M. 2017.04.14	Drawing No.	Sheet	Revision	
Dwn. Chkd. Dsgn. YYYY.MM.DD	D-303	<b>]4</b> of <b>]4</b>	0	

0 2' 4'